

GENERAL NOTES

CONTRACT DOCUMENTS:

CONTRACT DOCUMENTS CONSIST OF THE AGREEMENT, GENERAL CONDITIONS, SPECIFICATIONS, DETAIL BOOK AND DRAWINGS, WHICH ARE COOPERATIVE AND CONTINUOUS. WORK INDICATED OR REASONABLY IMPLIED IN ANY ONE OF THE DOCUMENTS SHALL BE SUPPLIED AS THOUGH FULLY COVERED IN ALL. ANY DISCREPANCIES BETWEEN THE PARTS SHALL BE REPORTED TO THE ARCHITECT PRIOR TO THE COMMENCEMENT OF WORK. THESE DRAWINGS ARE PART OF THE CONTRACT DOCUMENTS FOR THIS PROJECT. THESE DRAWINGS ARE THE GRAPHIC ILLUSTRATION OF THE WORK TO BE ACCOMPLISHED. ALL DIMENSIONS NOTED TAKE PRECEDENCE OVER SCALED DIMENSIONS. DIMENSIONS NOTED WITH "N.T.S." DENOTES NOT TO SCALE.

ORGANIZATION:

THE DRAWINGS FOLLOW A LOGICAL, INTERDISCIPLINARY FORMAT: ARCHITECTURAL DRAWINGS (A SHEETS), CIVIL DRAWINGS (C SHEETS), STRUCTURAL (S SHEETS), MECHANICAL AND PLUMBING (M SHEETS), ELECTRICAL (E SHEETS) AND LIGHTING (LTG SHEETS).

CODE COMPLIANCE:

ALL WORK, MATERIALS, AND ASSEMBLIES SHALL COMPLY WITH APPLICABLE STATE AND LOCAL CODES, ORDINANCES, AND REGULATIONS. THE CONTRACTOR, SUBCONTRACTORS, AND JOURNEYMEN OF THE APPROPRIATE TRADES SHALL PERFORM WORK TO THE HIGHEST STANDARDS OF CRAFTSMANSHIP AND IN ACCORDANCE WITH AIA DOCUMENT A201-SECTION 3. THE BUILDING INSPECTOR SHALL BE NOTIFIED BY THE CONTRACTOR WHEN THERE IS NEED OF INSPECTION AS REQUIRED BY THE INTERNATIONAL BUILDING CODE OR ANY LOCAL CODE OR ORDINANCE.

INTENT:

THESE DOCUMENTS ARE INTENDED TO INCLUDE ALL LABOR, MATERIALS, EQUIPMENT AND SERVICES REQUIRED TO COMPLETE THE WORK DESCRIBED HEREIN.

COORDINATION:

THE CONTRACTOR SHALL CAREFULLY STUDY AND COMPARE THE DOCUMENTS, VERIFY ACTUAL CONDITIONS AND REPORT ANY DISCREPANCIES, ERRORS OR OMISSIONS TO THE ARCHITECT IN A TIMELY MANNER. THE ARCHITECT SHALL CLARIFY OR PROVIDE REASONABLE ADDITIONAL INFORMATION REQUIRED FOR SUCCESSFUL EXECUTION. THE CONTRACTOR SHALL VERIFY AND COORDINATE ALL OPENINGS THROUGH FLOORS, CEILINGS AND WALLS WITH ALL ARCHITECTURAL, INTERIOR, STRUCTURAL, MECHANICAL AND PLUMBING, ELECTRICAL AND LIGHTING DRAWINGS. CONTRACTOR WILL ASSUME RESPONSIBILITY OF ITEMS REQUIRING COORDINATION AND RESOLUTION DURING THE BIDDING PROCESS.

SUBSTITUTIONS:


ANY MATERIALS PROPOSED FOR SUBSTITUTION OF THOSE SPECIFIED OR THE CALLED OUT BY TRADE NAME IN THESE DOCUMENTS SHALL BE PRESENTED TO THE ARCHITECT FOR REVIEW. THE CONTRACTOR SHALL SUBMIT SAMPLES WHEN REQUIRED BY THE ARCHITECT AND SUCH SAMPLES SHALL BE REVIEWED BY THE ARCHITECT BEFORE THE WORK IS PERFORMED. WORK MUST CONFORM TO THE REVIEWED SAMPLES. ANY WORK WHICH DOES NOT CONFORM SHALL BE REMOVED AND REPLACED WITH WORK WHICH CONFORMS AT THE CONTRACTOR'S EXPENSE. SUBCONTRACTORS SHALL SUBMIT REQUESTS AND SAMPLES FOR REVIEW THROUGH THE GENERAL CONTRACTOR WHEN WORK IS LET THROUGH HIM OR HER. REQUIRED VERIFICATION AND SUBMITTALS TO BE MADE IN ADEQUATE TIME AS NOT TO DELAY WORK IN PROGRESS.

SHOP DRAWINGS:

SHOP DRAWINGS SHALL BE SUBMITTED TO THE ARCHITECT FOR HIS OR HER REVIEW WHERE CALLED FOR ANYWHERE IN THESE DOCUMENTS. REVIEW SHALL BE MADE BY THE ARCHITECT BEFORE WORK IS BEGUN, AND WORK SHALL CONFORM TO THE REVIEWED SHOP DRAWINGS, SUBJECT TO REPLACEMENT AS REQUIRED IN PARAGRAPH "SUBSTITUTIONS" ABOVE.

SAFETY & PROTECTION OF WORK:

THE CONTRACTOR SHALL BE RESPONSIBLE FOR THE SAFETY AND CARE OF ADJACENT PROPERTIES DURING CONSTRUCTION FOR COMPLIANCE WITH FEDERAL AND STATE O.S.H.A. REGULATIONS, AND FOR THE PROTECTION OF ALL WORK UNTIL IT IS DELIVERED COMPLETED TO THE OWNER.

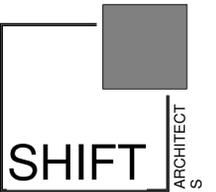

P.O. Box 3206
100 W. Colorado Suite 211
Telluride, Colorado 81435
p 970-728-8145
kristine@shift-architects.com
www.shift-architects.com

DATE:
REVISED HOA
SET 07.07.22

PROJECT CODE INFORMATION

ZONING	TOWN OF TELLURIDE; ACCOMMODATIONS DISTRICT 2
BUILDING CODE	IRC 2018
DESCRIPTION	MULTI-LEVEL CONDO
AUTOMATIC FIRE SPRINKLER	PER NFPA
SCOPE OF WORK	NEW BASEMENT LEVEL W/ ENTRY, NEW LIVING SPACE UNDER EXISTING DECK, EXPAND LIVING SPACE ON MAIN LEVEL TO EXTENTS OF EXISTING EXTERIOR WALL AND INTERIOR RENOVATIONS AS NOTED


PROJECT INFORMATION

TYPE OF UNIT	CONDO
EXISTING MAIN LEVEL / ENTRY	507 SF
EXISTING DECK	128 SF
EXISTING LOWER LEVEL	498 SF
PROPOSED MAIN LEVEL / ENTRY	535 SF
PROPOSED DECK	128 SF
PROPOSED LOWER LEVEL	498 SF
PROPOSED BASEMENT	635 SF
EXISTING FLOOR AREA	1,005 SF
PROPOSED FLOOR AREA	1,668 SF
PARKING REQUIRED	1 REQUIRED 1 PROVIDED

SHEET INDEX

GENERAL	
COVER SHEET	G1.0
ABBREVIATIONS & LEGENDS	G1.1
ARCHITECTURAL	
DEMO PLAN	D1.1
EXISTING FLOOR PLAN	A3.1
PROPOSED FLOOR PLANS	A3.2
FRAMING PLANS	A3.3
EXISTING ELEVATIONS	A4.1
PROPOSED ELEVATIONS	A4.2
SECTION	A5.1
WALL DETAILS	A7.1
FLASHING DETAILS	A7.2
FLASHING DETAILS	A7.3
WINDOW / DOOR DETAILS	A7.4
DETAILS	A7.5
SEALING DETAILS	A7.6
DOOR / WINDOW SCHEDULE	A8.1
SCHEDULES	A8.2
INTERIOR ELEVATIONS	A9.1
INTERIOR ELEVATIONS	A9.2
LIGHTING PLANS	LTG1.1
STRUCTURAL	
STRUCTURAL NOTES	S1
FLOOR FRAMING PLANS	S2
FLOOR FRAMING PLANS	S3

VICINITY MAP

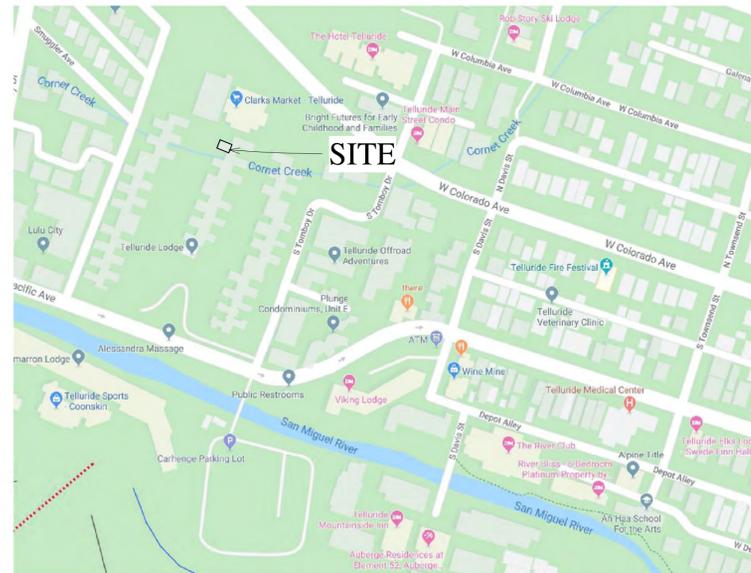

PROJECT TEAM

OWNER:

BROOKE MALLETTE & DAVID ROTHERMEL
747 W PACIFIC AVE UNIT 402
TELLURIDE, CO 81435
P.303.810.7320

ARCHITECT:

SHIFT ARCHITECTS
100 W COLORADO STE. 211
TELLURIDE, CO 81435
P. 970.275.0263
kristine@shift-architects.com

GENERAL CONTRACTOR:

KEES INDUSTRIES, LLC
BLAKE KEES
PO BOX 462
PLACERVILLE, CO 81430
P. 970-729-1731
BLAKEGKEES@GMAIL.COM

STRUCTURAL:

TELLURIDE ENGINEERING LLC
PO BOX 4045
TELLURIDE, CO 81435
P. 970.728.5440
JGARDNER.PE@GMAIL.COM

MALLETTE RESIDENCE


747 W PACIFIC AVE UNIT 402
TELLURIDE, CO 81435

COVER SHEET


SHEET NUMBER

G1.0

SYMBOL LEGEND

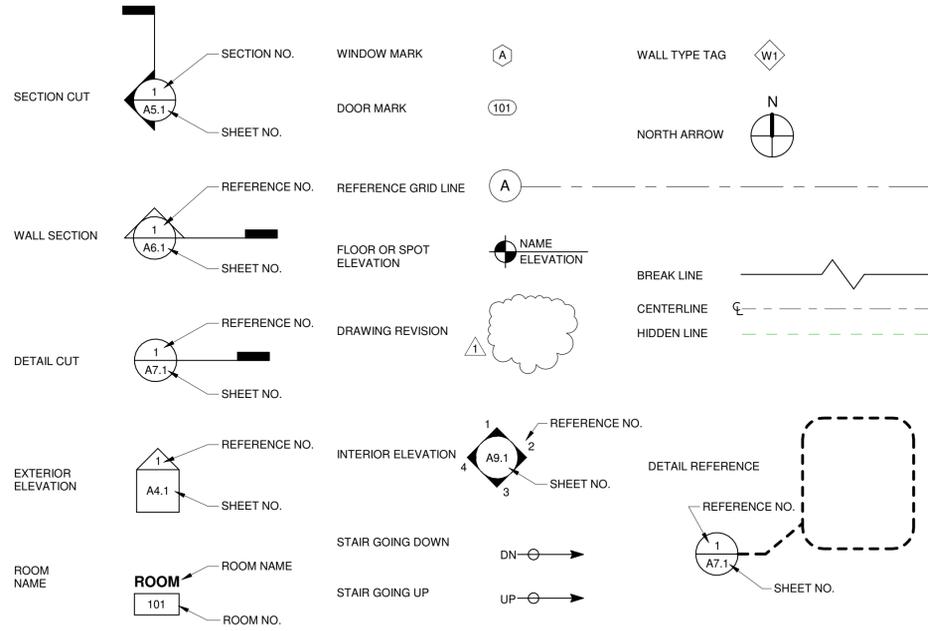


MATERIAL LEGEND

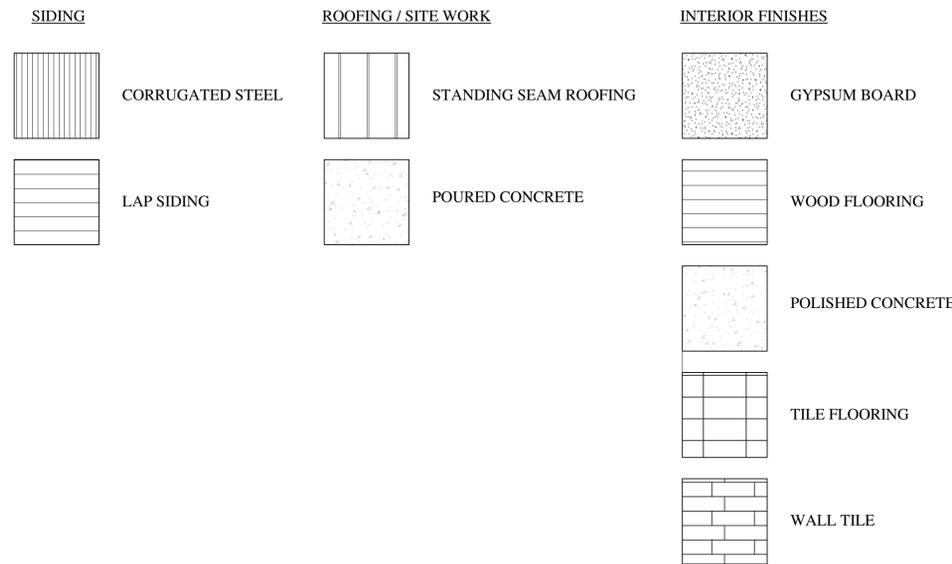

ABBREVIATIONS


AC	Acres
AFF	Above Finished Floor
AGG	Aggregate
AL	Aluminum
BM	Beam
BO	Bottom Of
BSN	Basin
BTH	Bath
CL	Centre Line
CJ	Control Join
CLST	Closet
CP	Carpet
CT	Ceramic Tile
DIA	Diameter
DP	Downpipe
DW	Dishwasher
EX	Existing
FF	Finished Floor
FP	Flue Pipe
GAL	Galvanized
GL	Ground Line
GFI	Ground Fault Circuit Interrupter
GPO	General Power Outlet
IRC	International Residential Building Code
IBC	International Building Code
MDF	Medium Density Fibreboard
MR	Metal Roofing
NTS	Not To Scale
OA	Over All
OH	Over Hang
PFC	Parallel Flanged Steel Channel
PT	Paint
RC	Reinforced Concrete
REF	Refrigerator
S	Sanitary Drainage Pipe
SHR	Shower
SK	Sink
SN	Stone
SS	Stainless Steel
ST	S Trap
STF	Steel Trowel Finished Concrete
SW	Stormwater Drainage Line
T&G	Tongue and Grooved
TO	Top Of
TOP	Top Of Plate
TPH	Toilet Paper Holder
TR	Tiled Roofing
TSF	Timber Strip Floor
TYP	Typical
UON	Unless Otherwise Noted
V	Valley
VIF	Verify In Field
VP	Vent Pipe
WC	Water Closet (Toilet)
WM	Washing Machine
WPM	Water Proof Membrane

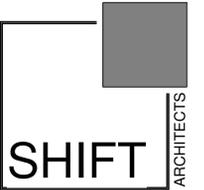

P.O. Box 3206
100 W. Colorado Suite 211
Telluride, Colorado 81435
p 970-728-8145
kristine@shift-architects.com
www.shift-architects.com


DATE:
REVISED HOA SET 07.07.22

WALL LEGEND

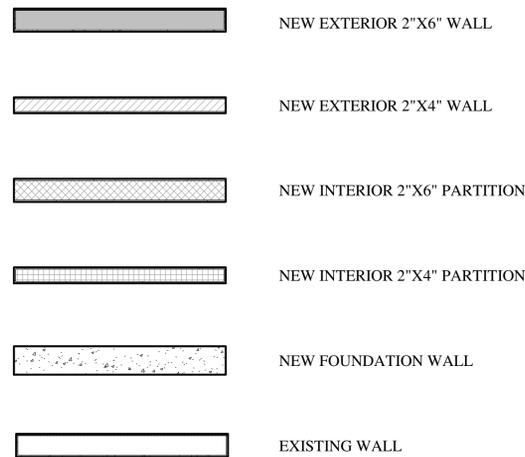

DIMENSIONING LEGEND

- GRIDS ALIGN WITH OUTSIDE FACE OF FOUNDATION WALL AND OUTSIDE FACE OF STUD AT EXTERIOR STRUCTURAL FRAME WALL.
- WALLS AND PARTITIONS SHOWN IN PLAN INCLUDE FINISH MATERIALS.
- DIMENSIONS ARE SHOWN FROM GRID TO GRID, GRID TO FACE OF STUD, GRID TO CENTERLINE OF WALL AND FACE OF STUD TO FACE OF STUD AT INTERIOR PARTITIONS, TYPICAL.
- WINDOWS AND DOORS DIMENSIONED TO CENTERLINE OF UNIT TYP.

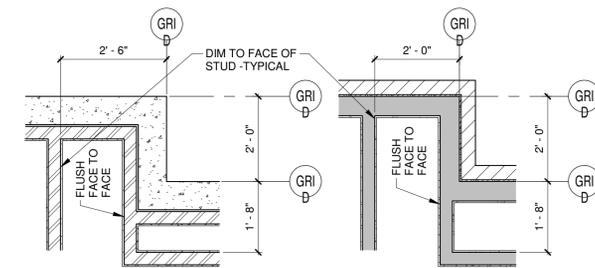

ACTUAL ELEVATION ABOVE SEA LEVEL = PROJECT 0'-0"



MALLETTE RESIDENCE

747 W PACIFIC AVE UNIT 402
TELLURIDE, CO 81435

ABBREVIATIONS &
LEGENDS

SHEET NUMBER


7/7/2022 4:36:44 PM

G1.1


©shift architects

- DEMOLITION KEYED NOTES:**
- EXISTING KITCHEN AND APPLIANCES TO BE REMOVED
 - EXISTING WINDOWS TO BE REMOVED
 - EXISTING FLOOR FINISHES TO BE REMOVED
 - EXISTING SIDING TO BE REMOVED AS NECESSARY
 - EXISTING PLUMBING FIXTURES TO BE REMOVED
 - EXISTING INTERIOR AND EXTERIOR WALLS TO BE REMOVED AS SHOWN
 - EXISTING FOUNDATION UNDER MAIN LEVEL TO BE REMOVED
 - EXISTING DECK TO BE REMOVED
 - INTERIOR AND EXTERIOR DOORS TO BE REMOVED. ENTRY DOOR FROM HALL TO REMAIN


- GENERAL DEMOLITION NOTES:**
- DEMOLITION INDICATED IS FOR GENERAL REFERENCE PURPOSES ONLY AND IS NOT INTENDED TO IDENTIFY ALL OF THE DEMOLITION, REMOVAL OF FINISHES, ETC. GENERAL CONTRACTOR SHALL BE RESPONSIBLE FOR ALL DEMOLITION NECESSARY TO ACCOMMODATE NEW WORK WHETHER INDICATED OR NOT.
 - THE CONTRACTOR MUST ADHERE TO THE SCOPE OF WORK SHOWN ON THE DRAWINGS. NO WORK IS AUTHORIZED IF IT EXPANDS THE ORIGINAL SCOPE OF WORK UNLESS IT IS APPROVED IN WRITING BY THE OWNER/ARCHITECT. ANY WORK UNDERTAKEN BY THE CONTRACTOR AND ANY ADDITIONAL REQUIRED DOCUMENTATION OR COST TO THE PROJECT WITHOUT PRIOR WRITTEN APPROVAL IS THE SOLE RESPONSIBILITY OF THE CONTRACTOR.
 - VERIFY EXISTING STRUCTURE PRIOR TO DEMOLITION.
 - ANY DISCREPANCIES ARE TO BE BROUGHT TO THE ATTENTION OF THE ARCHITECT.
 - PROTECT ALL AREAS OF EXTERIOR FINISH ADJACENT TO DEMOLISHED ELEMENTS. PATCH AND REPAIR TO MATCH EXISTING CONDITIONS IF AFFECTED DURING CONSTRUCTION.
- DASHED LINES INDICATE REMOVAL OF EXISTING
 ■ EXISTING WALLS TO REMAIN

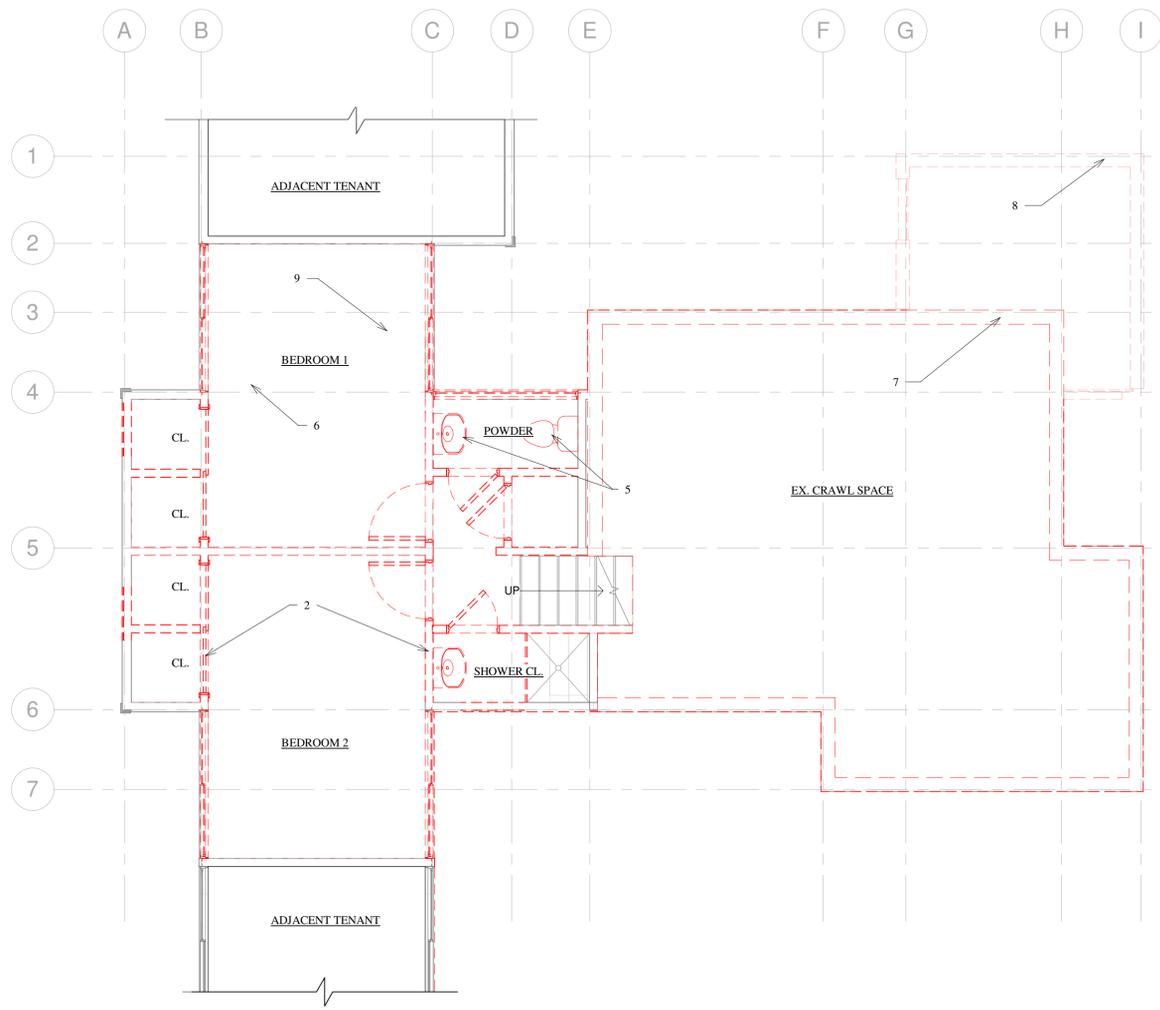


1 LOWER LEVEL DEMO PLAN
1/4" = 1'-0"

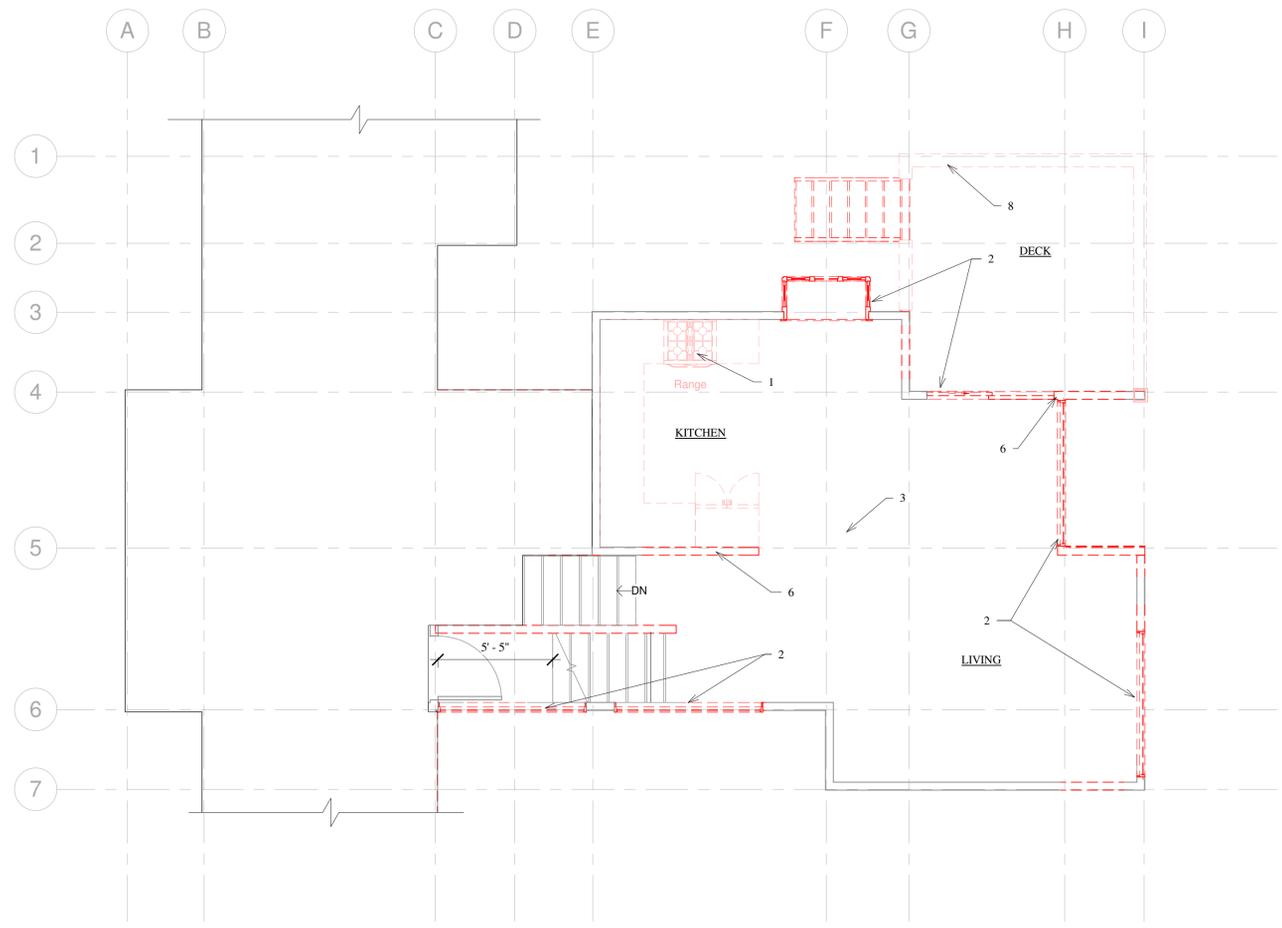


2 MAIN LEVEL DEMO PLAN
1/4" = 1'-0"

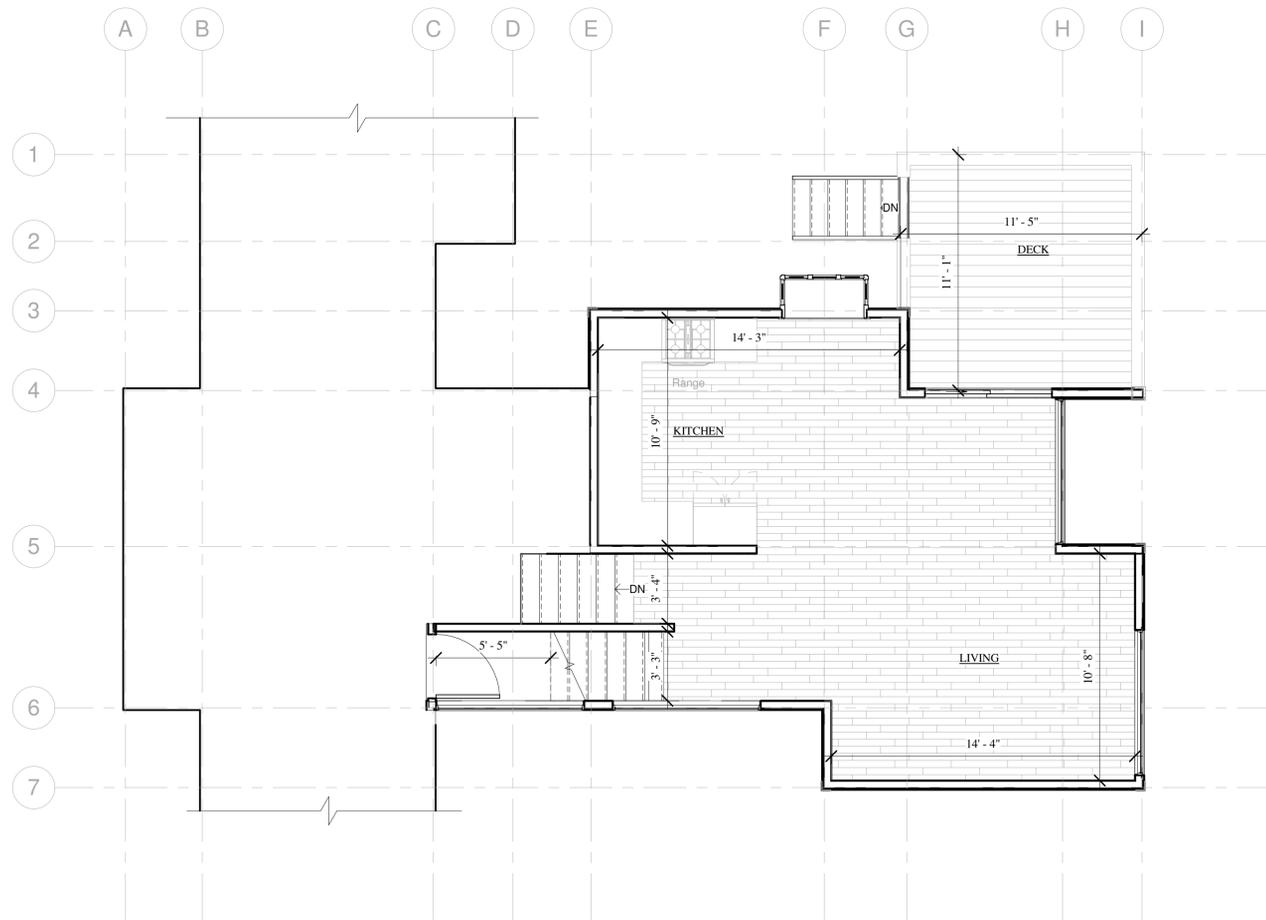

① EXISTING MAIN LEVEL
 1/4" = 1'-0"

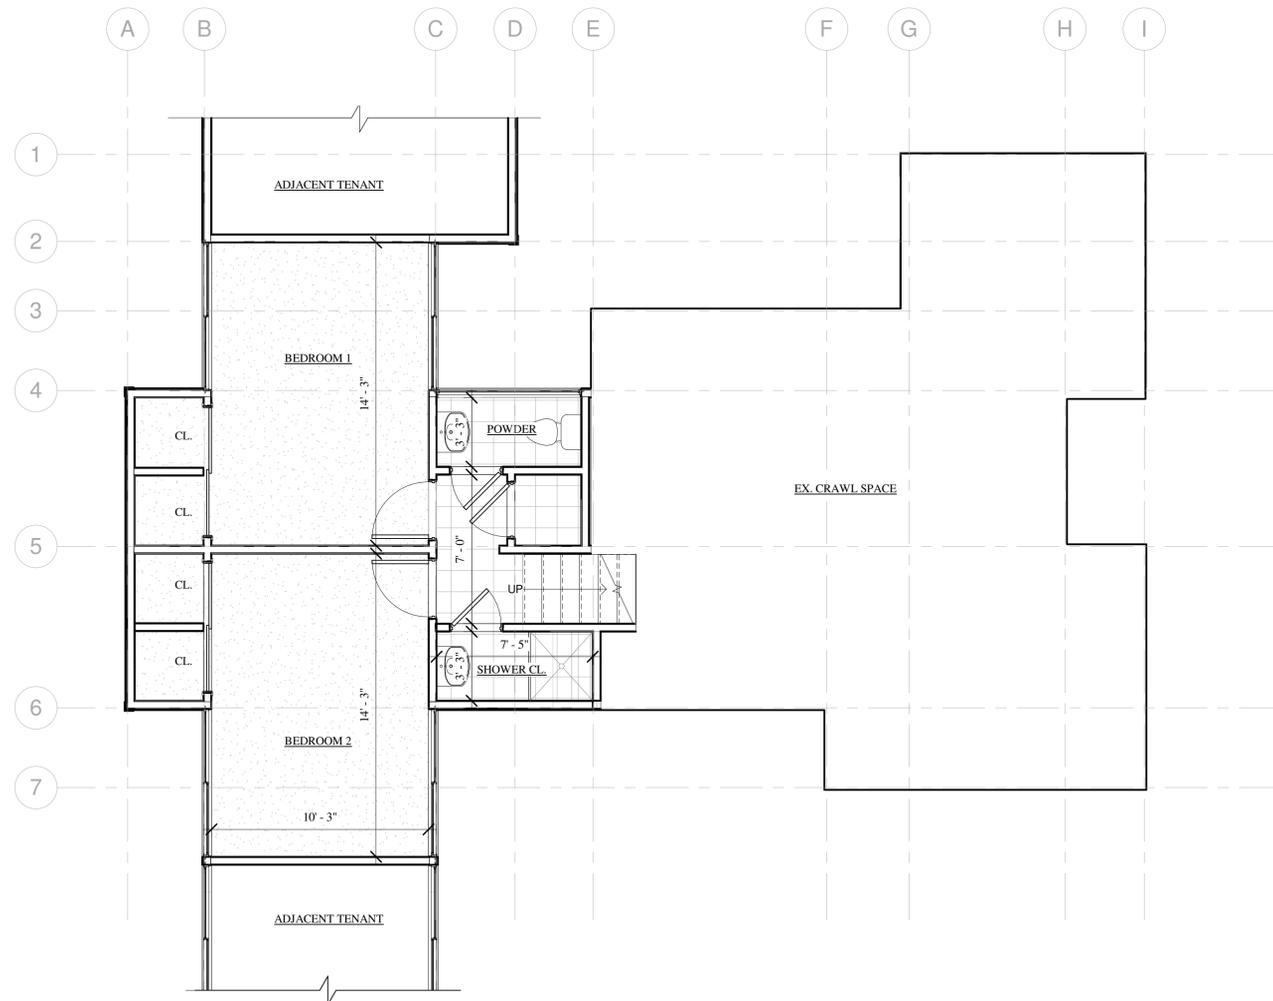

② EXISTING LOWER LEVEL
 1/4" = 1'-0"

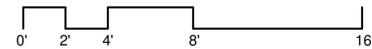


MALLETTE RESIDENCE

747 W PACIFIC AVE UNIT 402
 TELLURIDE, CO 81435


EXISTING FLOOR
 PLAN

SHEET NUMBER



A3.1

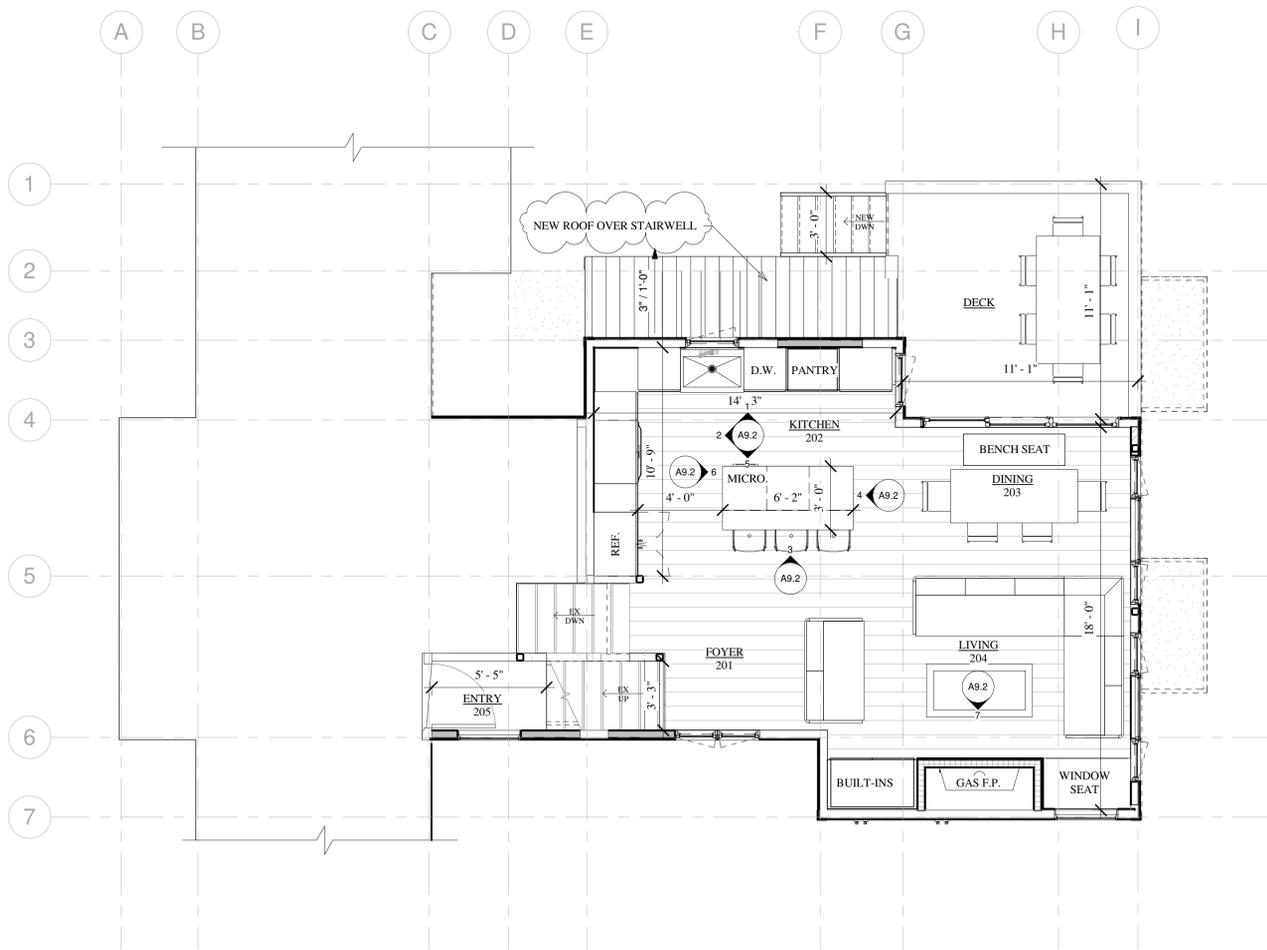

1 PROPOSED MAIN LEVEL
 1/4" = 1'-0"

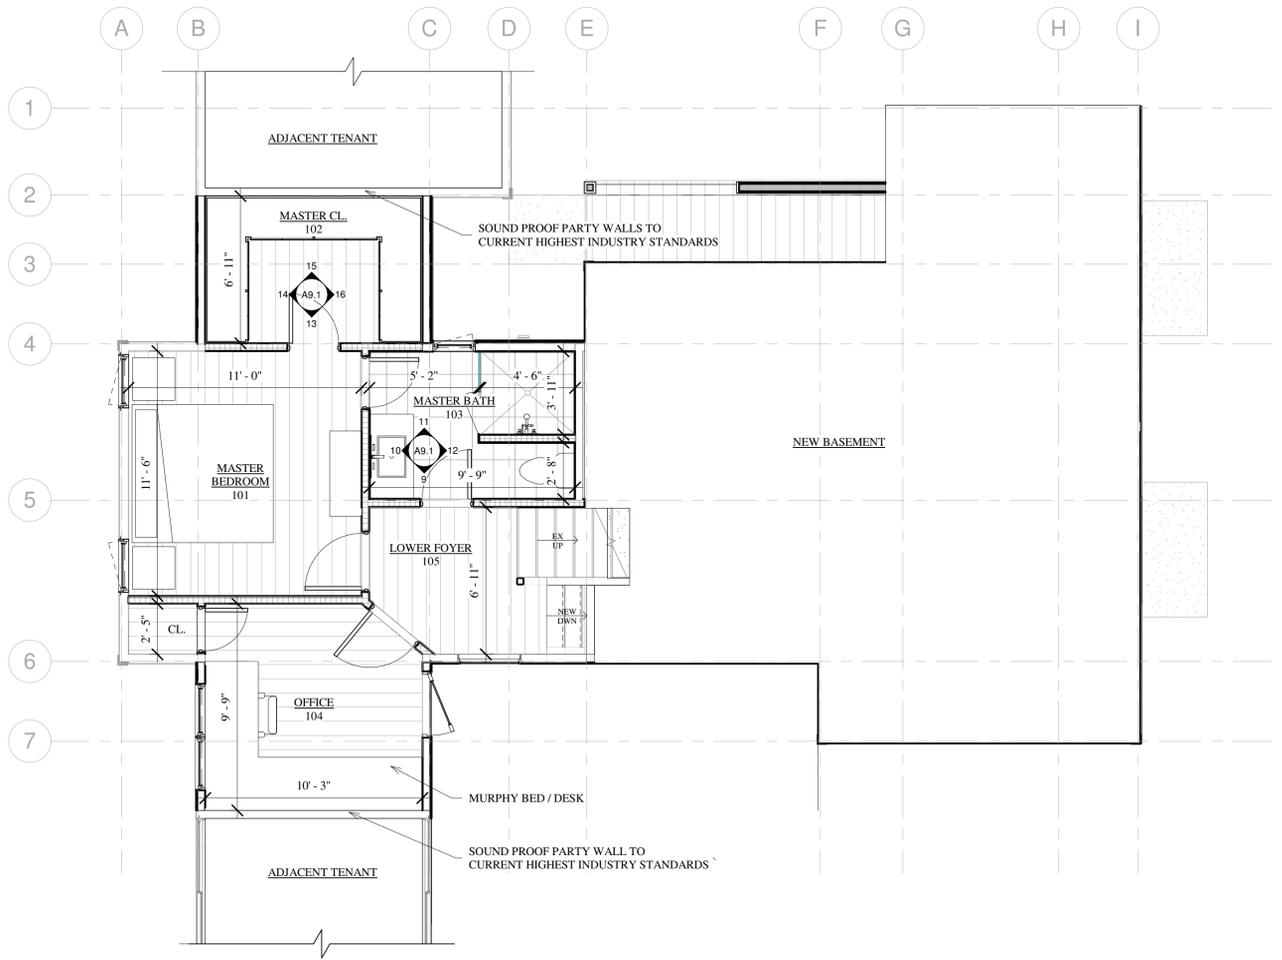

2 PROPOSED LOWER LEVEL
 1/4" = 1'-0"

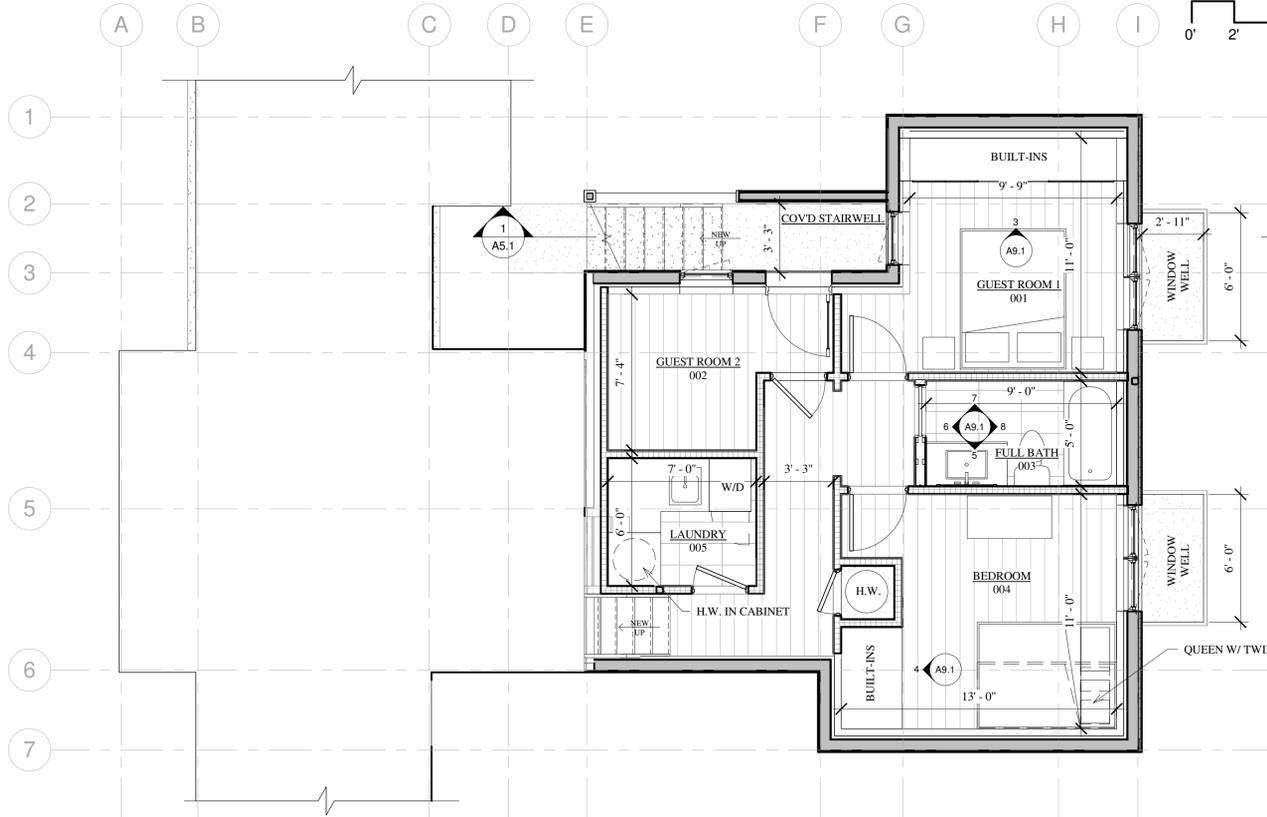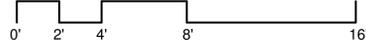

3 NEW BASEMENT
 1/4" = 1'-0"


MALLETTE RESIDENCE

747 W PACIFIC AVE UNIT 402
 TELLURIDE, CO 81435


PROPOSED FLOOR
 PLANS

SHEET NUMBER


A3.2

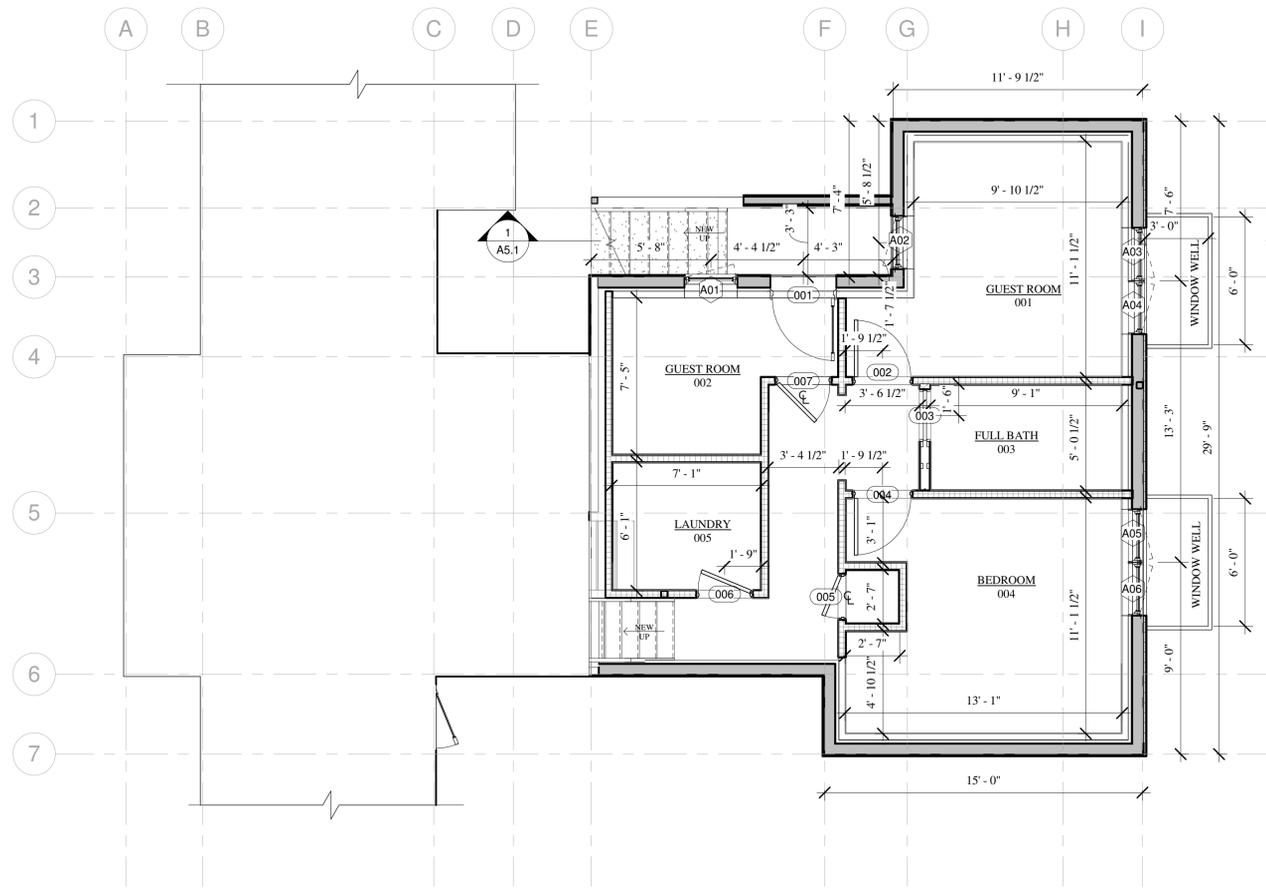

1 BASEMENT FRAMING PLAN
1/4" = 1'-0"

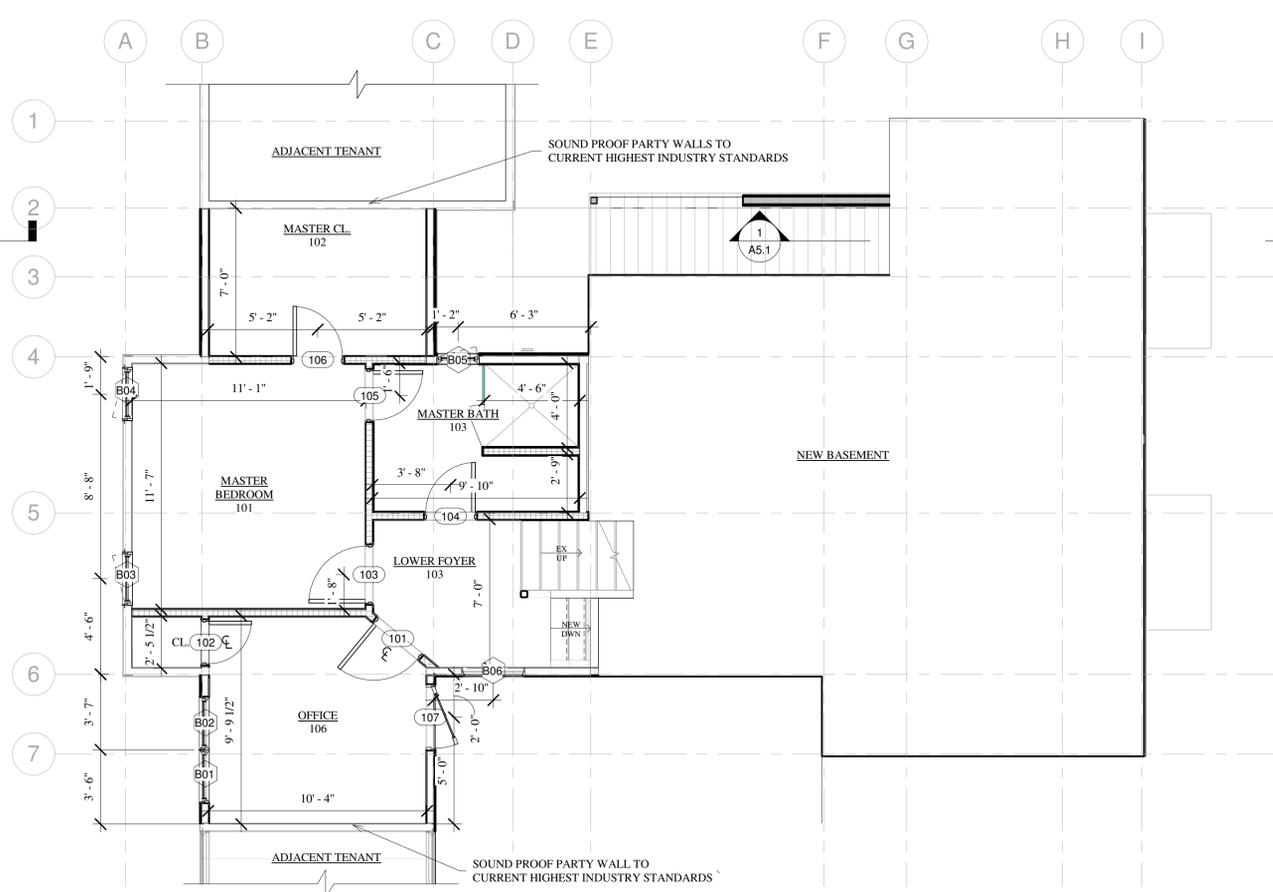

2 LOWER LEVEL FRAMING PLAN
1/4" = 1'-0"

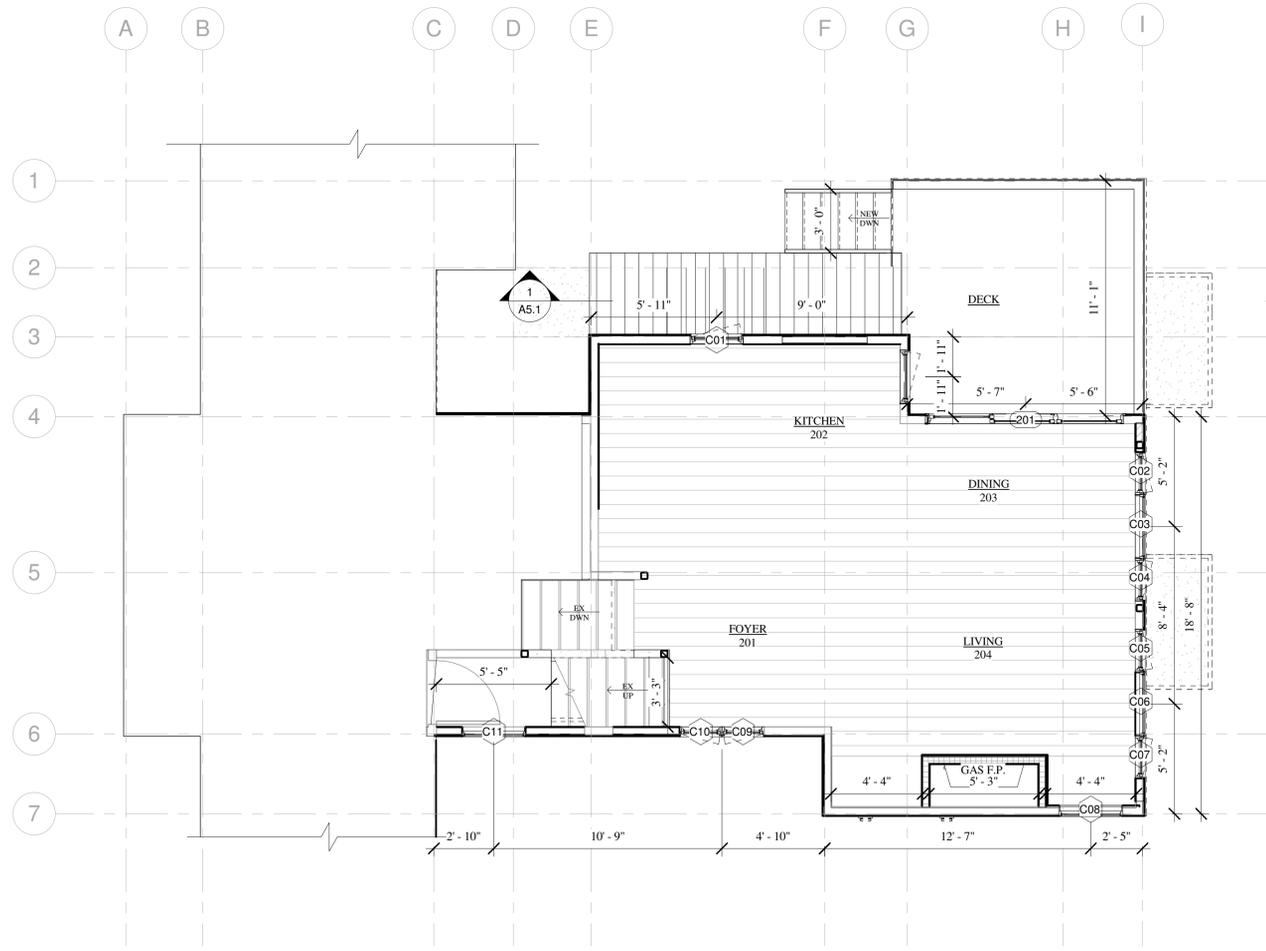

3 MAIN LEVEL FRAMING PLAN
1/4" = 1'-0"

DIMENSION NOTE: EXTERIOR DIMENSIONS ARE FROM GRID LINE TO GRID LINE AND TO CENTERLINE OF WALL, WINDOWS AND DOORS. INTERIOR DIMENSIONS ARE FROM FRAMING EDGE TO FRAMING EDGE AND TO CENTERLINE OF DOORS AND WINDOWS.

- NEW EXTERIOR 2"x6" WALL
- NEW EXTERIOR 2"x4" WALL
- NEW INTERIOR 2"x6" PARTITION
- NEW INTERIOR 2"x4" PARTITION
- NEW FOUNDATION WALL
- EXISTING WALL

MALLETTE RESIDENCE


747 W PACIFIC AVE UNIT 402
 TELLURIDE, CO 81435

EXISTING
 ELEVATIONS


SHEET NUMBER

A4.1


7/7/2022 4:36:21 PM

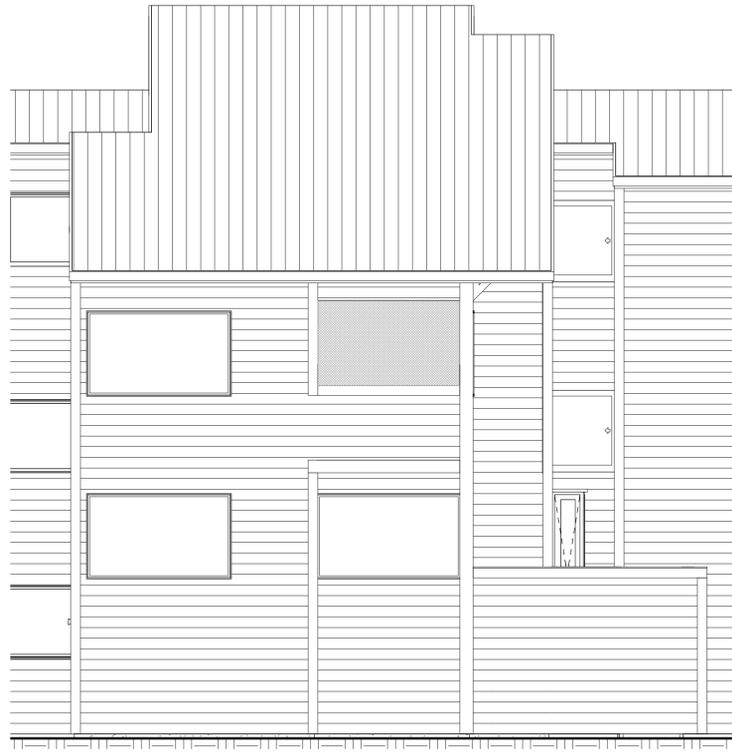


③ WEST EXISTING
 1/4" = 1'-0"

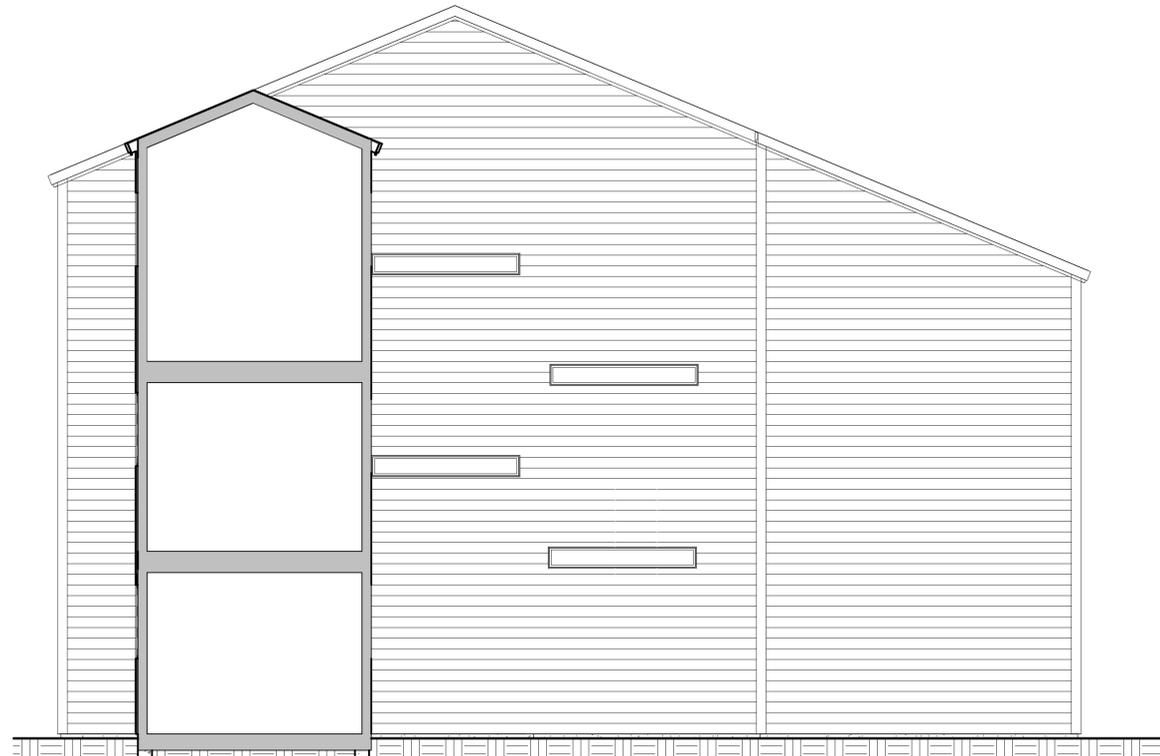


④ NORTH EXISTING
 1/4" = 1'-0"

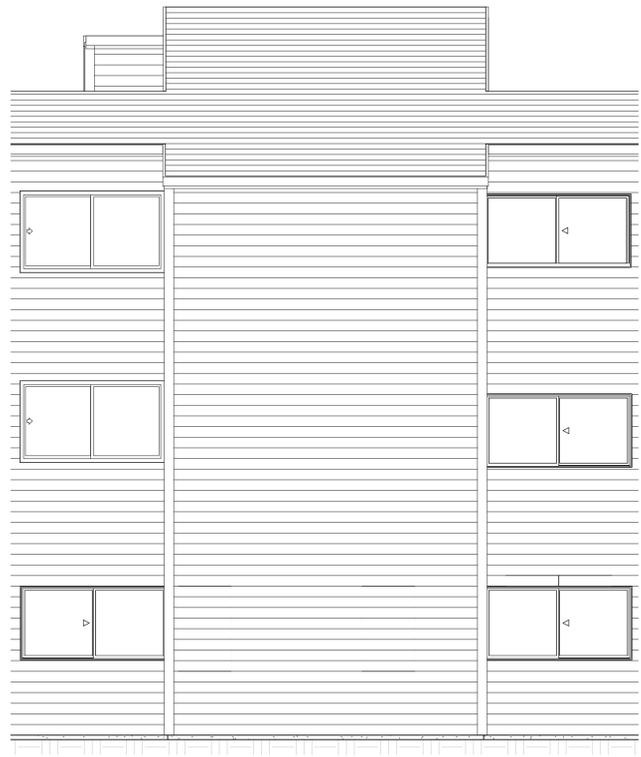


② EAST EXISTING
 1/4" = 1'-0"

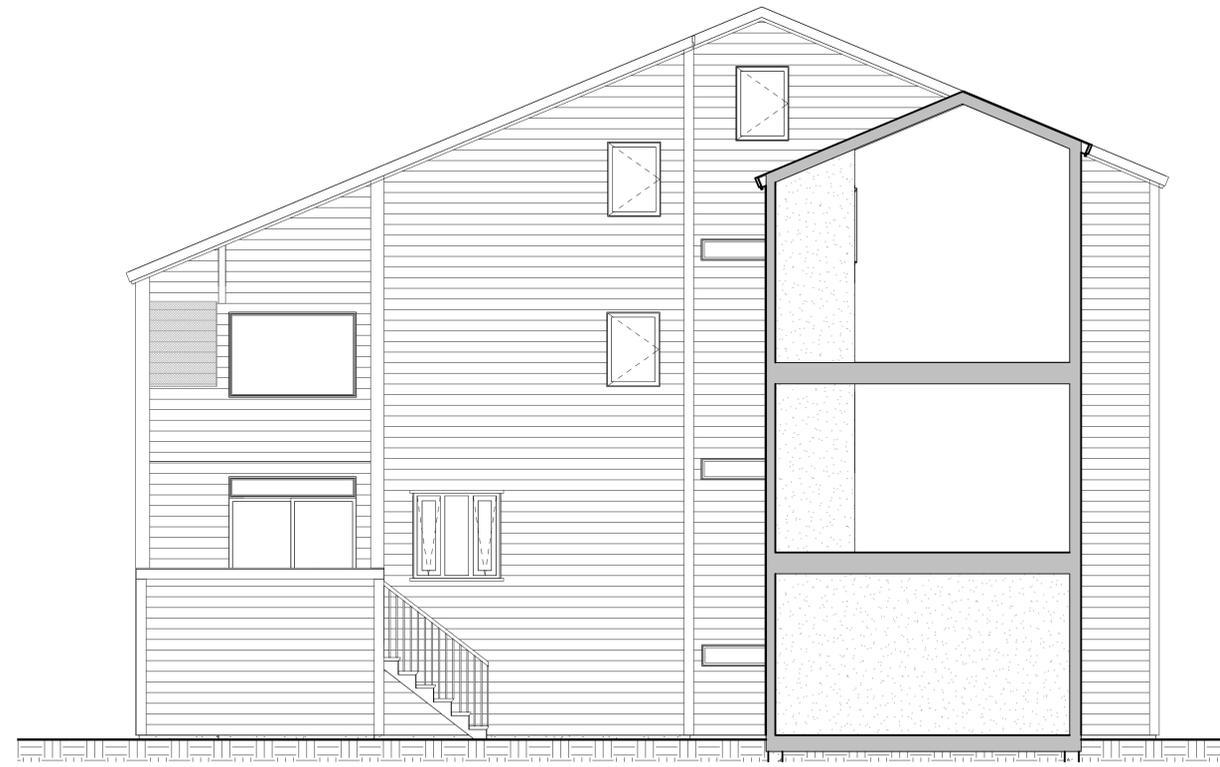

① SOUTH EXISTING
 1/4" = 1'-0"

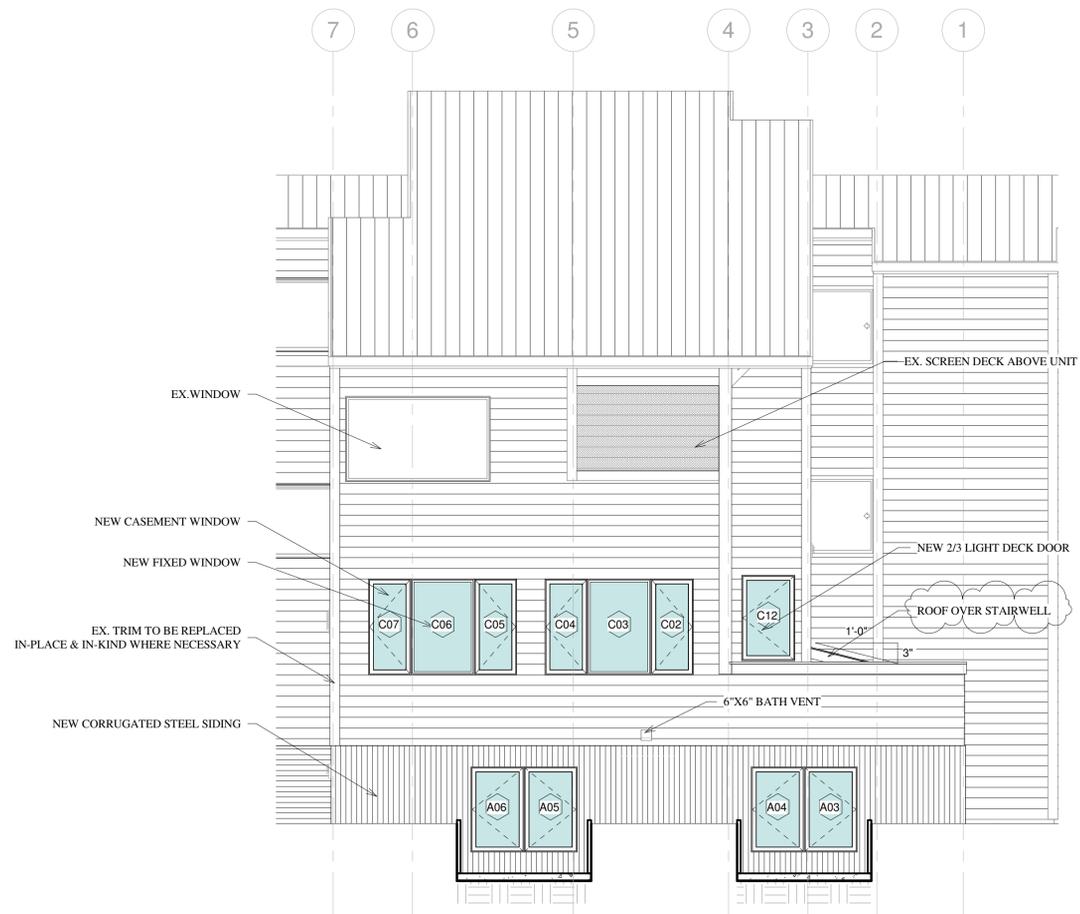


① WEST PROPOSED
1/4" = 1'-0"

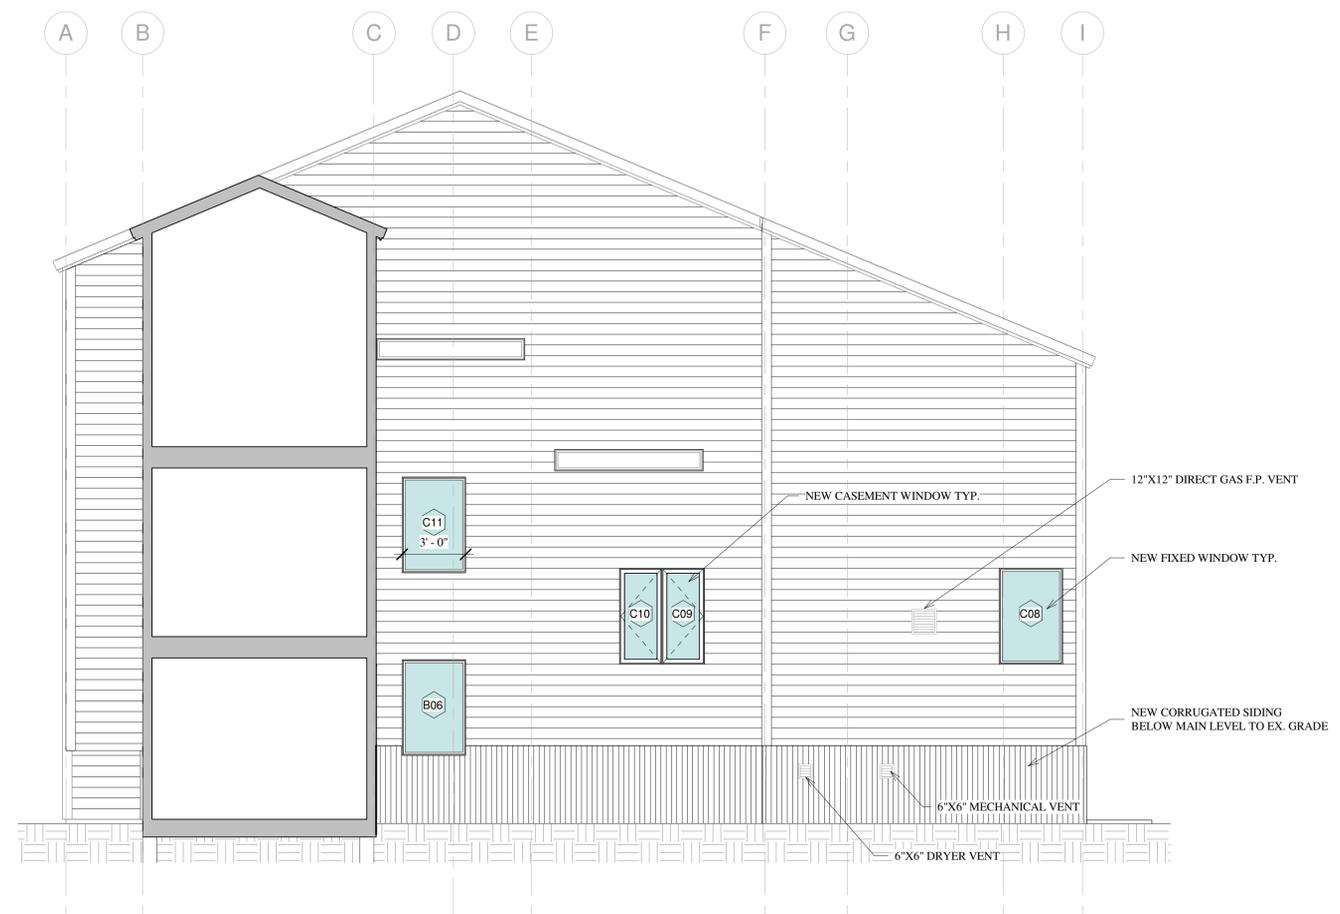

② NORTH PROPOSED
1/4" = 1'-0"



③ EAST PROPOSED
1/4" = 1'-0"

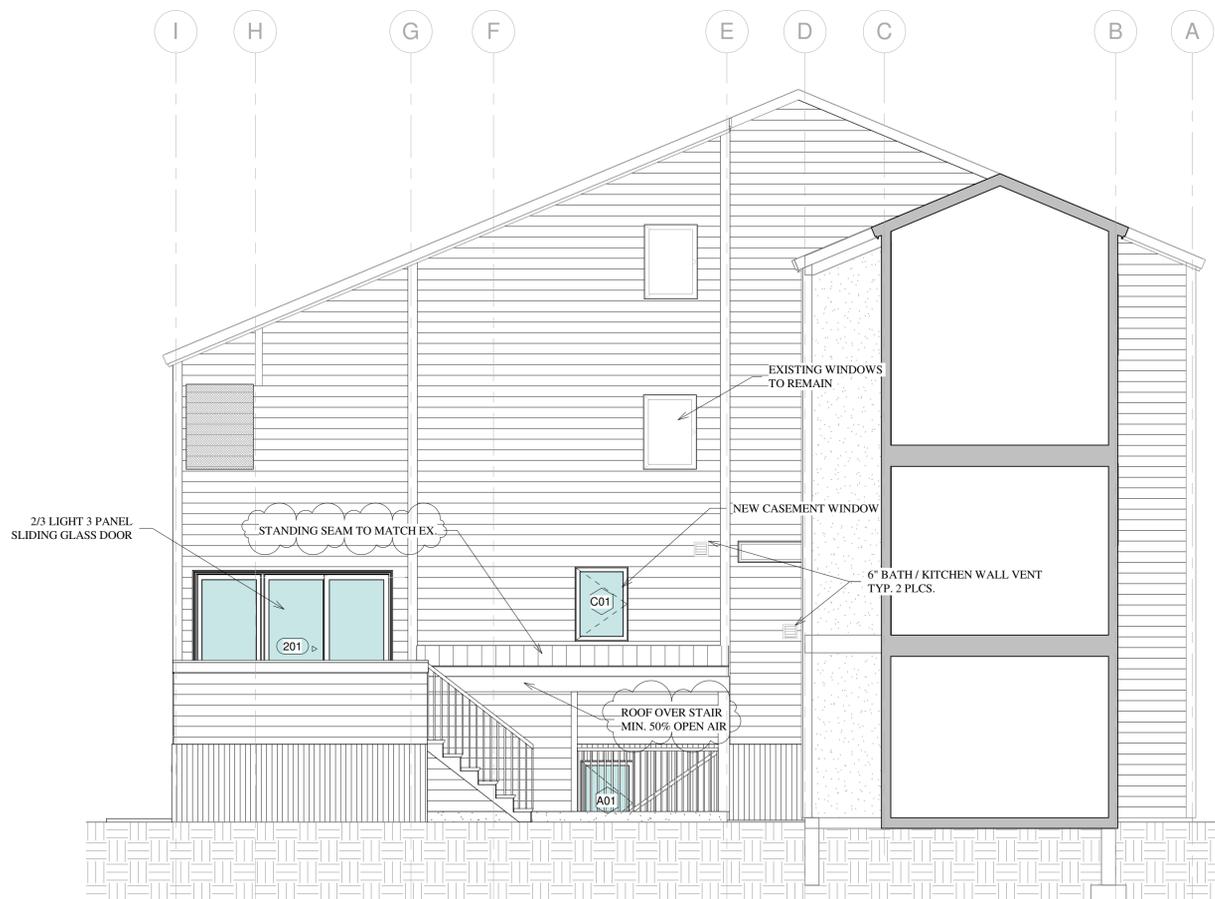

④ SOUTH PROPOSED
1/4" = 1'-0"


MALLETTE RESIDENCE

747 W PACIFIC AVE UNIT 402
TELLURIDE, CO 81435

PROPOSED
ELEVATIONS

SHEET NUMBER

A4.2

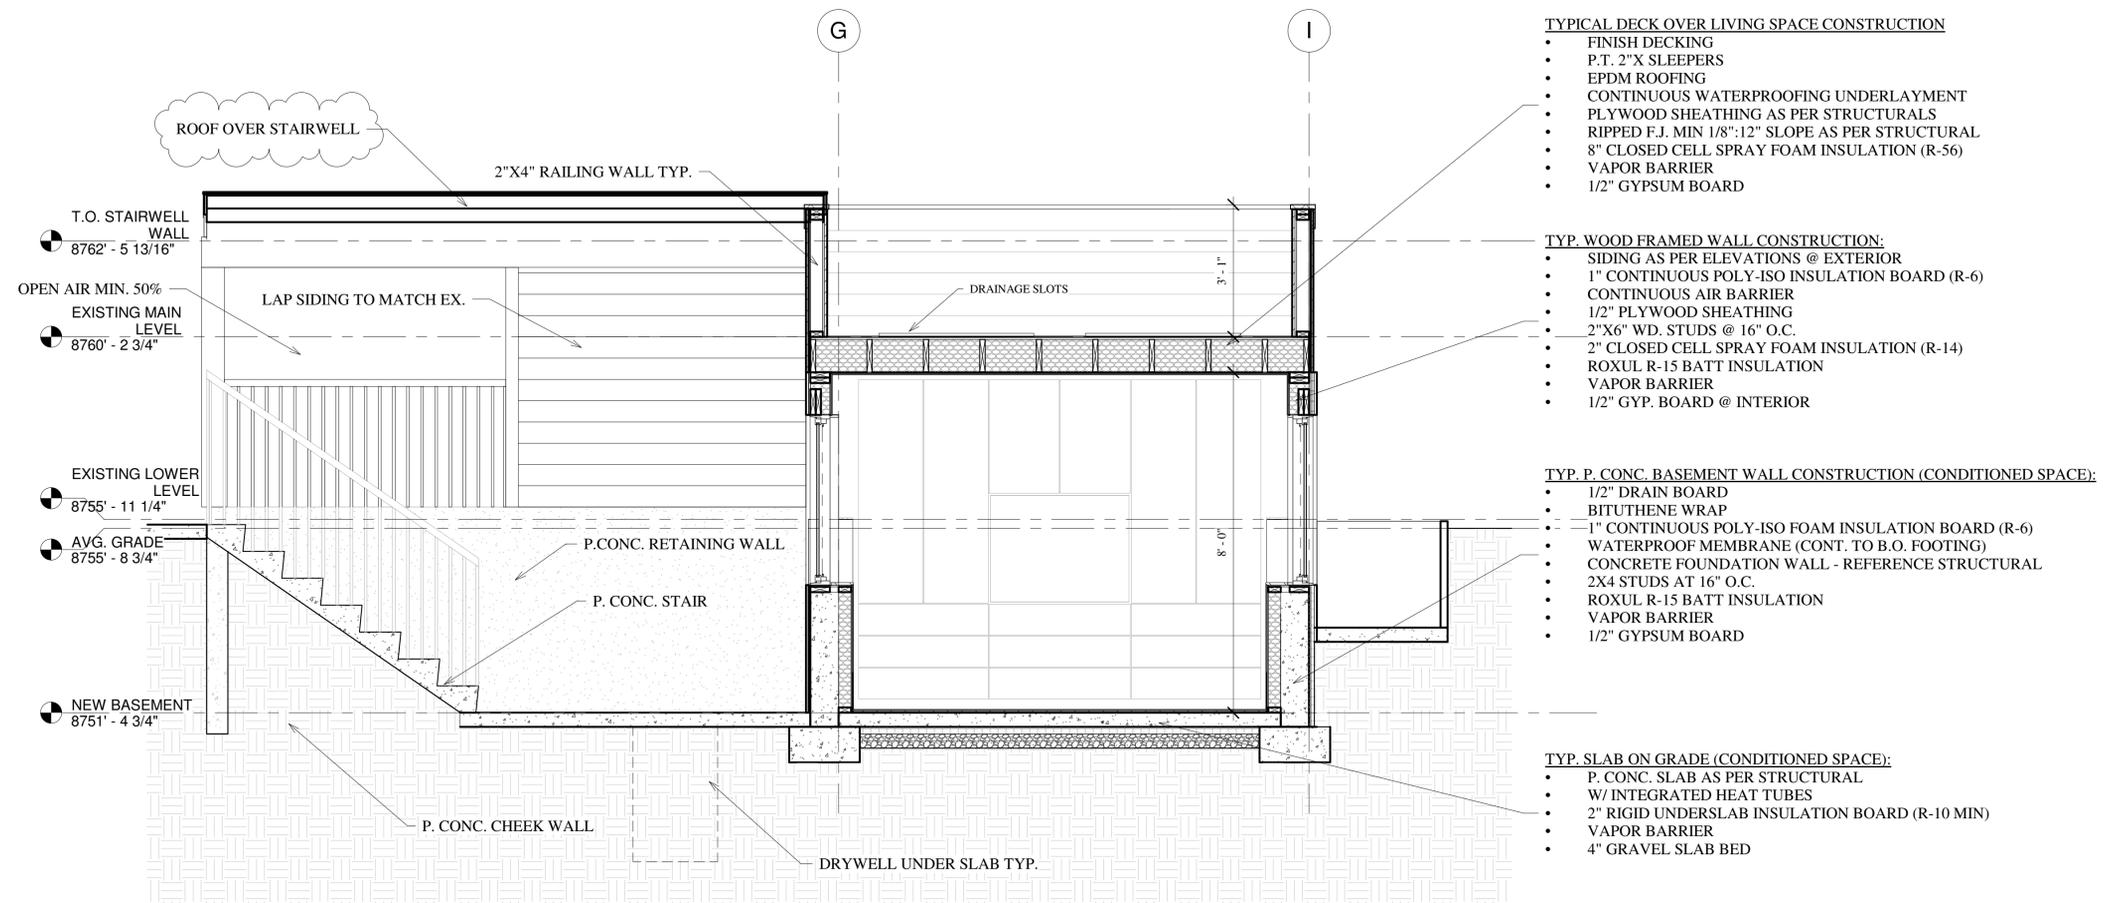

1 DECK OVER LIVING SPACE
 1/2" = 1'-0"

MALLETTE RESIDENCE


747 W PACIFIC AVE UNIT 402
 TELLURIDE, CO 81435

SECTION


SHEET NUMBER

A5.1


7/7/2022 4:36:24 PM

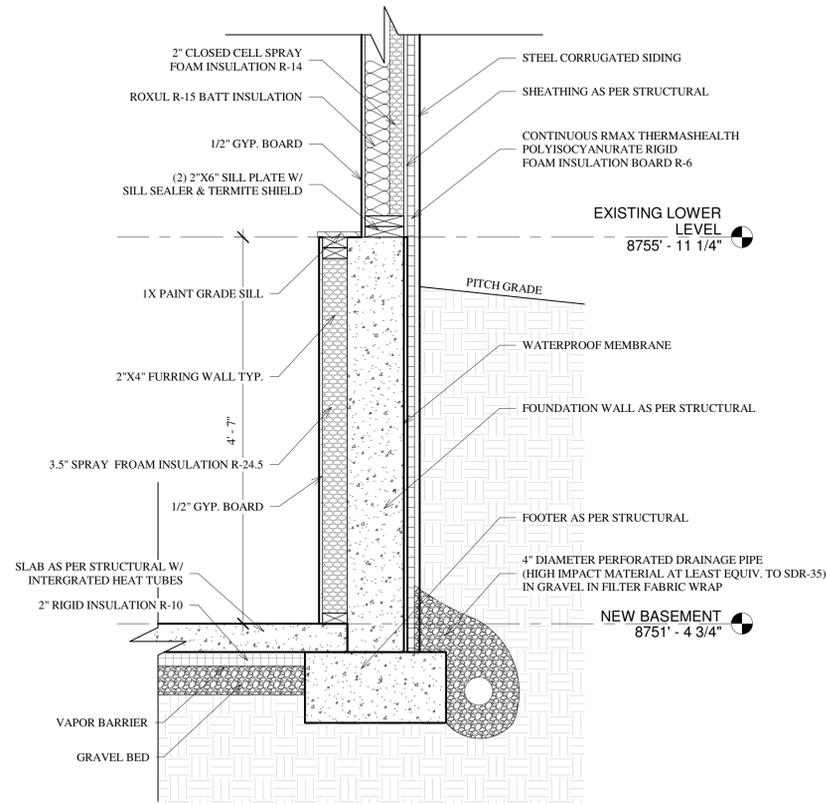


① NEW BASEMENT WALL
 1" = 1'-0"

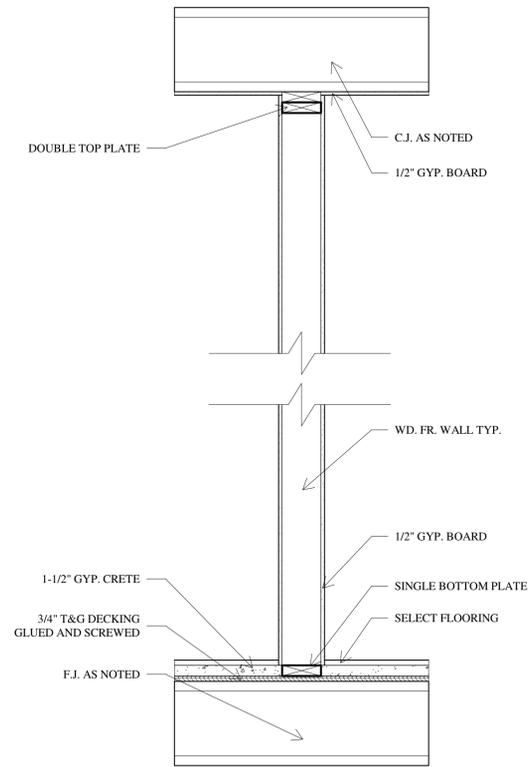

② INTERIOR PARTITION DETAIL
 1" = 1'-0"

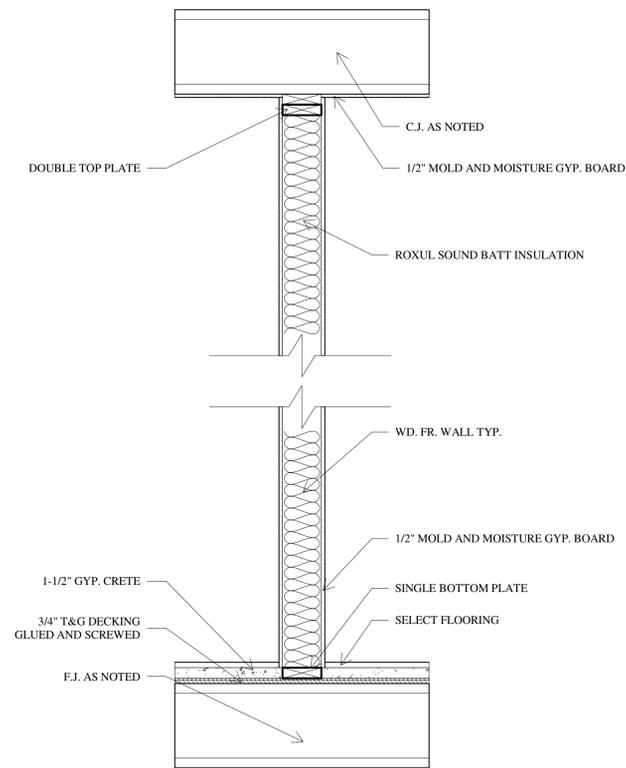


⑤ INTERIOR PARTITION @ BATH DETAIL
 1" = 1'-0"

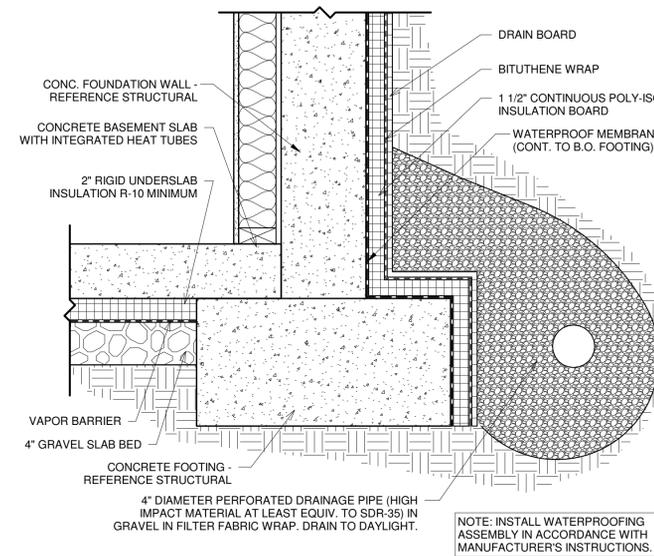


⑦ CONCRETE FOOTING DETAIL
 1 1/2" = 1'-0"

F1 - HEAD FLASHING

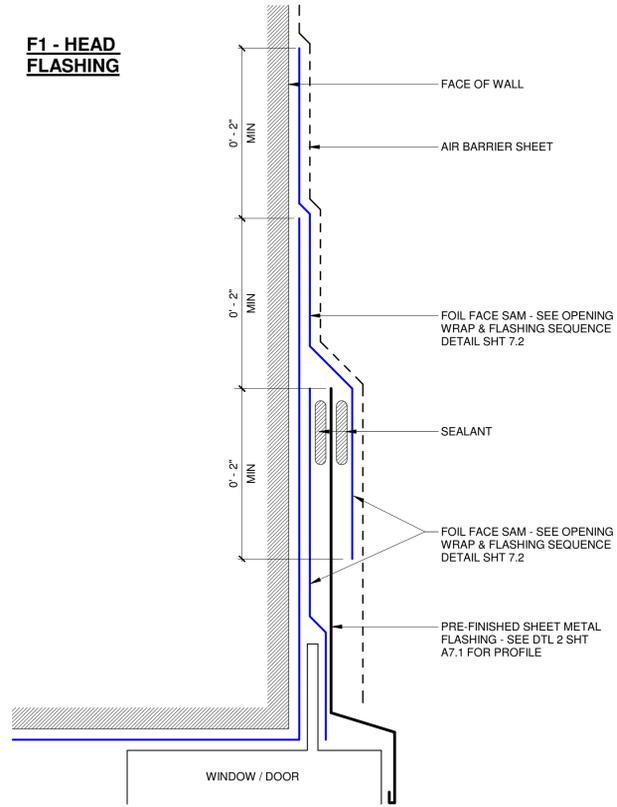


F2 - HEAD FLASHING

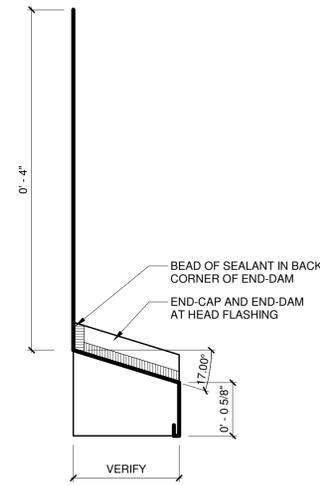


NOTES:
1. MATERIAL TO BE PRE-FINISHED SHEET METAL.
2. END-DAMS TO BE BENT AND CRIMPED.
3. SEAL END-DAMS SO THAT THERE ARE NO PIN HOLES.
4. PROFILE TO BE VERIFIED PER THE MOCK-UP PROCESS.

F3 - TRIM FLASHING

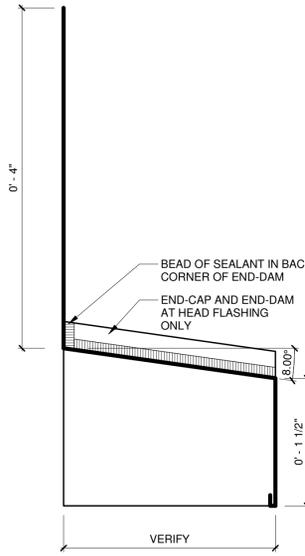


NOTES:
1. MATERIAL TO BE PRE-FINISHED SHEET METAL.
2. ALL JOINTS AND CORNERS TO UTILIZE STANDING SEAMS.
3. SEAL END-DAMS SO THAT THERE ARE NO PIN HOLES.
4. PROFILE TO BE VERIFIED PER THE MOCK-UP PROCESS.

F4 - THRU-WALL FLASHING

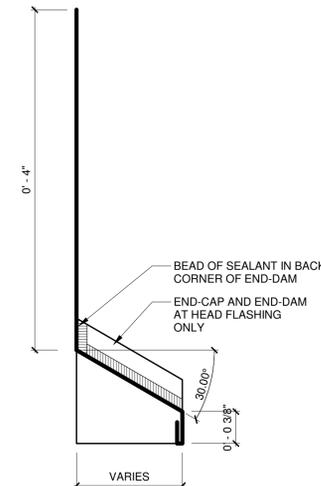

NOTES:
1. MATERIAL TO BE PRE-FINISHED SHEET METAL.
2. ALL JOINTS AND CORNERS TO UTILIZE STANDING SEAMS.
3. SEAL END-DAMS SO THAT THERE ARE NO PIN HOLES.
4. PROFILE TO BE VERIFIED PER THE MOCK-UP PROCESS.

F5 - FLASHING

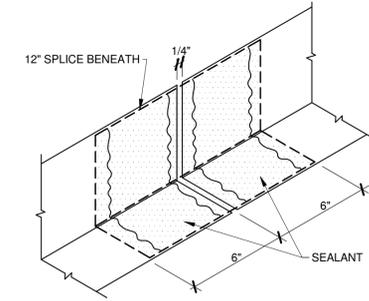


1 F1 - HEAD FLASHING

2 F2 - FLASHING PROFILE

3 F3 - FLASHING PROFILE


4 F4 - FLASHING PROFILE

5 TYP LAP JOINT AT FLASHING

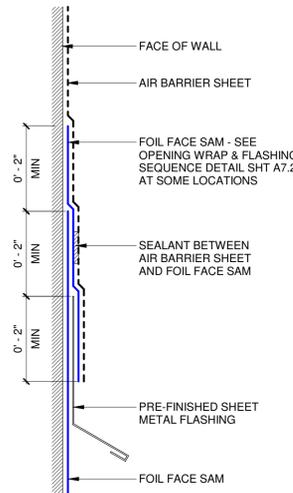


EXTERIOR FINISH MATERIAL TRANSITION

A

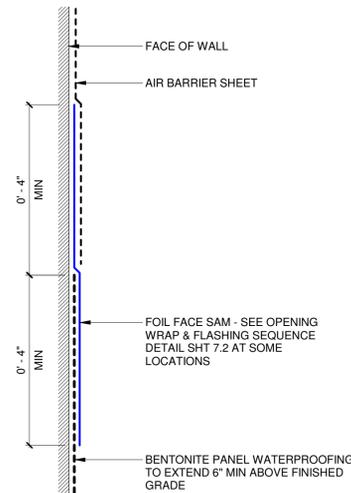


FRAME WALL AT FOUNDATION

B

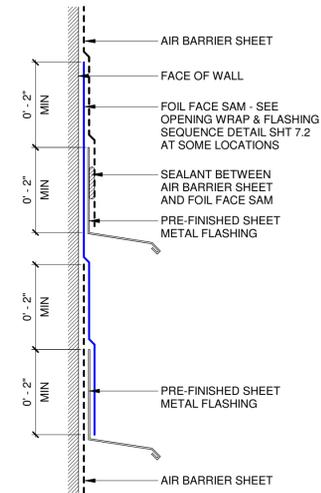

STONE CAP

C

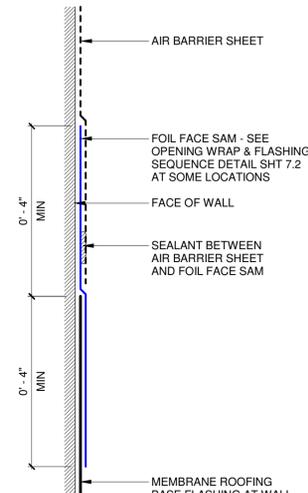


ROOF TO VERTICAL WALL

D

6 AIR BARRIER MATERIAL TRANSITIONS

STEP 1

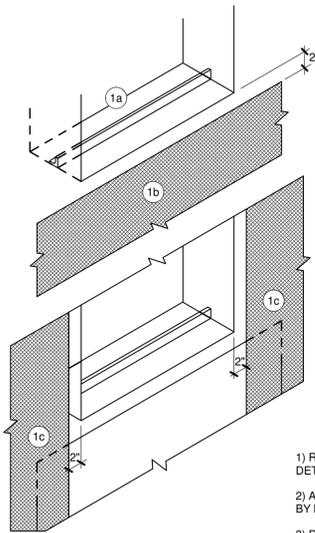


- a) INSTALL 1 1/2" X 1 1/2" ALUM ANGLE ON SILL FRAMING PER WINDOW SILL DETAIL.
- b) INSTALL AIR BARRIER SHEET. HOLD 2" DOWN FROM SILL.
- c) INSTALL AIR BARRIER SHEET. HOLD 2" BACK FROM JAMBS. EXTEND 7" ABOVE TOP OF WINDOW OPENING.


GENERAL NOTES:

- 1) REPRESENTS TYPICAL. SEE WINDOW DETAILS FOR ADDITIONAL INFO.
- 2) APPLY PRIMER TO SURFACES CONTACTED BY MEMBRANE FLASHING.
- 3) ROLLER OVER MEMBRANE FLASHING TO ACHIEVE GOOD ADHESION TO SUBSTRATE.
- 4) SEALANT INDICATED IS DOW CWS.
- 5) SEAL EDGES OF MEMBRANE FLASHING TO THE AIR BARRIER SHEET.
- 6) THIS PROCEDURE SEQUENCE SHALL ALSO BE APPLIED TO EXTERIOR DOOR OPENINGS USING THE APPLICABLE HEAD AND JAMB DETAILS.

STEP 2

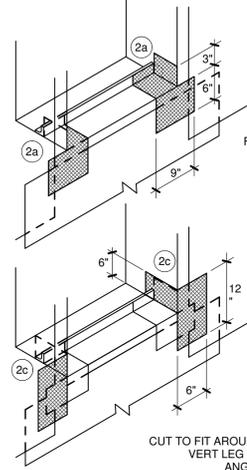


- a) INSTALL FOIL-FACED MEMBRANE FLASHING PARTS 2a ON SILL AND EXTEND MEMBRANE UP ALUM ANGLE. EXTEND MEMBRANE UP JAMB FRAMING, ONTO WALL SHEATHING AND DOWN OVER SILL AIR BARRIER SHEET.
- b) APPLY PRIMER TO SURFACES WHERE CORNER PARTS 2b WILL OVERLAP CORNER PARTS 2a.
- c) INSTALL FOIL-FACED MEMBRANE FLASHING PARTS 2b ON JAMB FRAMING AND EXTEND MEMBRANE DOWN OVER MEMBRANE FLASHING PARTS 2a.

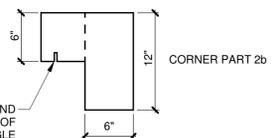


GENERAL NOTES:

- 1) REPRESENTS TYPICAL. SEE WINDOW DETAILS FOR ADDITIONAL INFO.
- 2) APPLY PRIMER TO SURFACES CONTACTED BY MEMBRANE FLASHING.
- 3) ROLLER OVER MEMBRANE FLASHING TO ACHIEVE GOOD ADHESION TO SUBSTRATE.
- 4) SEALANT INDICATED IS DOW CWS.
- 5) SEAL EDGES OF MEMBRANE FLASHING TO THE AIR BARRIER SHEET.
- 6) THIS PROCEDURE SEQUENCE SHALL ALSO BE APPLIED TO EXTERIOR DOOR OPENINGS USING THE APPLICABLE HEAD AND JAMB DETAILS.

STEP 3

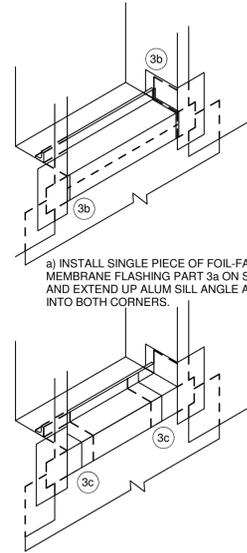

- b) APPLY SILICONE SEALANT LIBERALLY TO CORNER JUNCTURE AS SHOWN.

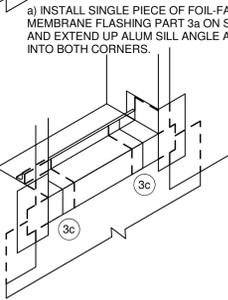


- a) INSTALL SINGLE PIECE OF FOIL-FACED MEMBRANE FLASHING PART 3a ON SILL AND EXTEND UP ALUM SILL ANGLE AND INTO BOTH CORNERS.
- c) APPLY SEALANT TO SEAM WHERE SILL PIECE TERMINATES ON MEMBRANE FLASHING CORNER PARTS 2a.

GENERAL NOTES:

- 1) REPRESENTS TYPICAL. SEE WINDOW DETAILS FOR ADDITIONAL INFO.
- 2) APPLY PRIMER TO SURFACES CONTACTED BY MEMBRANE FLASHING.
- 3) ROLLER OVER MEMBRANE FLASHING TO ACHIEVE GOOD ADHESION TO SUBSTRATE.
- 4) SEALANT INDICATED IS DOW CWS.
- 5) SEAL EDGES OF MEMBRANE FLASHING TO THE AIR BARRIER SHEET.
- 6) THIS PROCEDURE SEQUENCE SHALL ALSO BE APPLIED TO EXTERIOR DOOR OPENINGS USING THE APPLICABLE HEAD AND JAMB DETAILS.

STEP 4

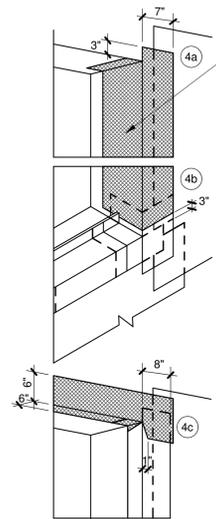


- EXTEND BEYOND INTERIOR SEALANT JOINT
- a) INSTALL 12-INCH WIDE MEMBRANE FLASHING AT JAMBS. EXTEND 3" ABOVE HEAD, CUT AND FOLD INWARD AND ONTO UNDERSIDE OF HEADER AS SHOWN.
- b) HOLD UP 3" FROM SILL AT JAMB AS SHOWN.
- c) INSTALL 12-INCH WIDE MEMBRANE FLASHING AT HEAD. EXTEND 5" BEYOND EACH JAMB, CUT AND FOLD INWARD AND ONTO UNDERSIDE OF HEADER AS SHOWN.

GENERAL NOTES:

- 1) REPRESENTS TYPICAL. SEE WINDOW DETAILS FOR ADDITIONAL INFO.
- 2) APPLY PRIMER TO SURFACES CONTACTED BY MEMBRANE FLASHING.
- 3) ROLLER OVER MEMBRANE FLASHING TO ACHIEVE GOOD ADHESION TO SUBSTRATE.
- 4) SEALANT INDICATED IS DOW CWS.
- 5) SEAL EDGES OF MEMBRANE FLASHING TO THE AIR BARRIER SHEET.
- 6) THIS PROCEDURE SEQUENCE SHALL ALSO BE APPLIED TO EXTERIOR DOOR OPENINGS USING THE APPLICABLE HEAD AND JAMB DETAILS.

1 OPENING WRAP / FLASHING SEQUENCE 2 OPENING WRAP / FLASHING SEQUENCE 3 OPENING WRAP / FLASHING SEQUENCE 4 OPENING WRAP / FLASHING SEQUENCE

STEP 5

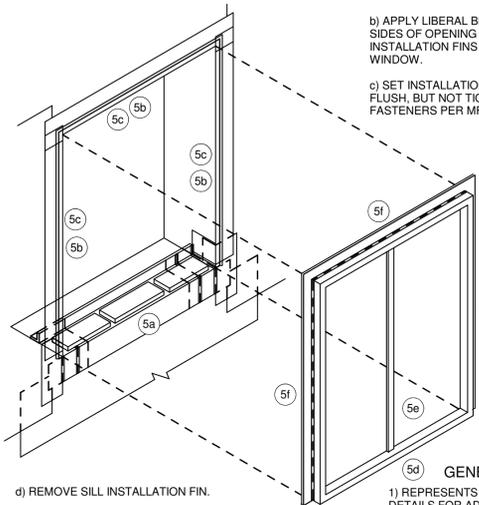


- a) INSTALL 3/8" SHIMS ON SILL. ONE AT EACH JAMB, ONE AT EACH VERTICAL MULLION AND 18" O.C. IN BETWEEN. DO NOT PLACE SHIMS IN FRONT OF WEEPS. PROVIDE 1" SPACE BETWEEN SHIM AND JAMB AND BETWEEN SHIMS.
- b) APPLY LIBERAL BEAD OF SEALANT TO TOP AND SIDES OF OPENING BELOW WINDOW INSTALLATION FINNS PRIOR TO PLACEMENT OF WINDOW.
- c) SET INSTALLATION FIN FASTENER HEADS FLUSH, BUT NOT TIGHT. DO NOT BEND OVER FASTENERS PER MFR'S INSTRUCTIONS.

GENERAL NOTES:

- d) REMOVE SILL INSTALLATION FIN.
 - e) SET WINDOW IN OPENING PER MFR'S INSTRUCTIONS. ADJUST AND SHIM AS REQ'D FOR SQUARE, PLUMB AND LEVEL INSTALLATION.
 - f) APPLY CONTINUOUS BEAD OF SEALANT AT JUNCTURE OF EXTERIOR WINDOW FRAME AND INSTALLATION FIN AT HEAD AND JAMBS.
- 1) REPRESENTS TYPICAL. SEE WINDOW DETAILS FOR ADDITIONAL INFO.
 - 2) APPLY PRIMER TO SURFACES CONTACTED BY MEMBRANE FLASHING.
 - 3) ROLLER OVER MEMBRANE FLASHING TO ACHIEVE GOOD ADHESION TO SUBSTRATE.
 - 4) SEALANT INDICATED IS DOW CWS.
 - 5) SEAL EDGES OF MEMBRANE FLASHING TO THE AIR BARRIER SHEET.
 - 6) THIS PROCEDURE SEQUENCE SHALL ALSO BE APPLIED TO EXTERIOR DOOR OPENINGS USING THE APPLICABLE HEAD AND JAMB DETAILS.

STEP 6

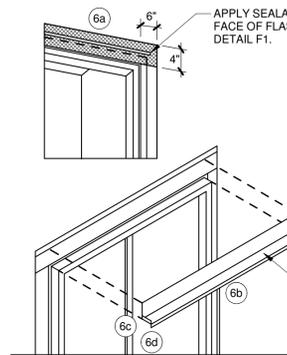


- APPLY SEALANT BETWEEN SAM AND BACK FACE OF FLASHING UPLEG. SEE FLASHING DETAIL F1.
- a) INSTALL 4-INCH WIDE MEMBRANE FLASHING OVER THE FIN OF THE WINDOW AT HEAD. EXTEND 6" BEYOND EACH JAMB.

FOR SLOPE - SEE FLASHING PROFILE F2.

GENERAL NOTES:

- b) INSTALL METAL HEAD FLASHING WEATHER LAPPED PER WINDOW HEAD DETAIL.
 - c) FOLD AND SEAL METAL HEAD FLASHING ENDS TO CREATE 1/2" UPTURNED END DAMS. SLOPE FLASHING PROFILE AT 1:3 PER DETAIL.
 - d) ADD END-CAP OVER DAMS. BOTTOM OF CAP TO ALIGN WITH TOP OF EXTERIOR DRIP.
- 1) REPRESENTS TYPICAL. SEE WINDOW DETAILS FOR ADDITIONAL INFO.
 - 2) APPLY PRIMER TO SURFACES CONTACTED BY MEMBRANE FLASHING.
 - 3) ROLLER OVER MEMBRANE FLASHING TO ACHIEVE GOOD ADHESION TO SUBSTRATE.
 - 4) SEALANT INDICATED IS DOW CWS.
 - 5) SEAL EDGES OF MEMBRANE FLASHING TO THE AIR BARRIER SHEET.
 - 6) THIS PROCEDURE SEQUENCE SHALL ALSO BE APPLIED TO EXTERIOR DOOR OPENINGS USING THE APPLICABLE HEAD AND JAMB DETAILS.

STEP 7

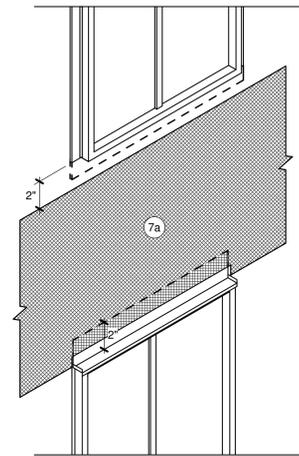


- a) INSTALL AIR BARRIER SHEET. EXTEND FROM 2" BELOW SILL OPENING ABOVE. CUT AIR BARRIER SHEET 2" ABOVE HEAD FLASHING AS SHOWN.
- INTERIOR BACKER ROD AND SEALANT APPLIED BETWEEN WINDOW FRAME AND FOIL-FACED MEMBRANE AT ALL JAMB AND HEAD DETAILS.

GENERAL NOTES:


- 1) REPRESENTS TYPICAL. SEE WINDOW DETAILS FOR ADDITIONAL INFO.
- 2) APPLY PRIMER TO SURFACES CONTACTED BY MEMBRANE FLASHING.
- 3) ROLLER OVER MEMBRANE FLASHING TO ACHIEVE GOOD ADHESION TO SUBSTRATE.
- 4) SEALANT INDICATED IS DOW CWS.
- 5) SEAL EDGES OF MEMBRANE FLASHING TO THE AIR BARRIER SHEET.
- 6) THIS PROCEDURE SEQUENCE SHALL ALSO BE APPLIED TO EXTERIOR DOOR OPENINGS USING THE APPLICABLE HEAD AND JAMB DETAILS.

5 OPENING WRAP / FLASHING SEQUENCE 6 OPENING WRAP / FLASHING SEQUENCE 7 OPENING WRAP / FLASHING SEQUENCE

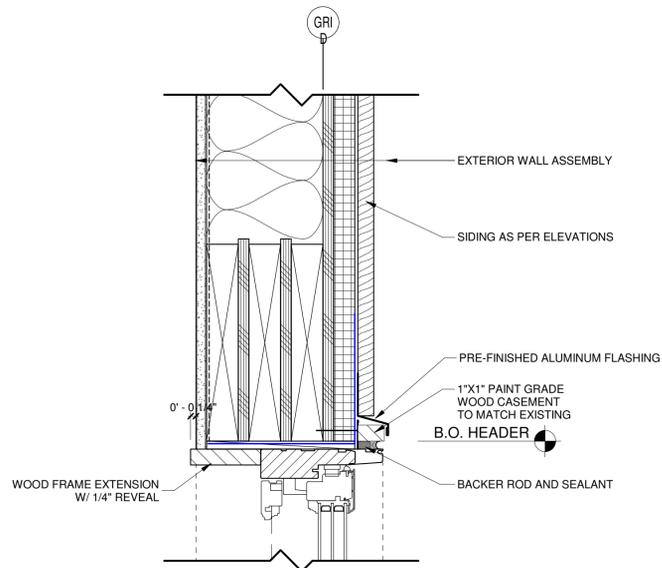


1 WINDOW HEAD @ SIDING

3" = 1'-0"

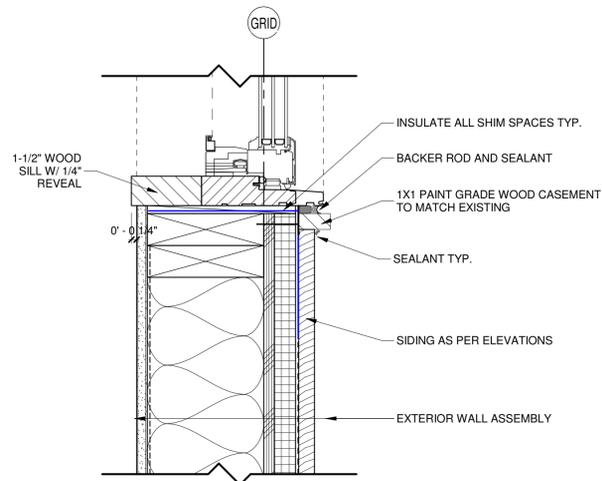


2 WINDOW SILL @ SIDING

3" = 1'-0"

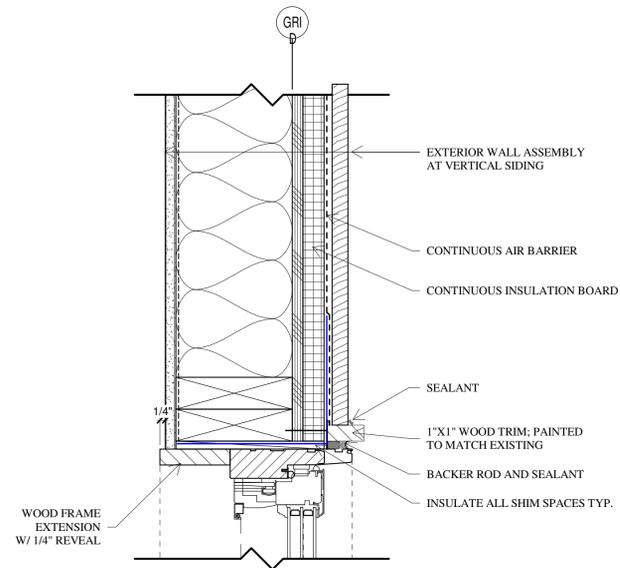


3 WINDOW JAMB @ SIDING

3" = 1'-0"

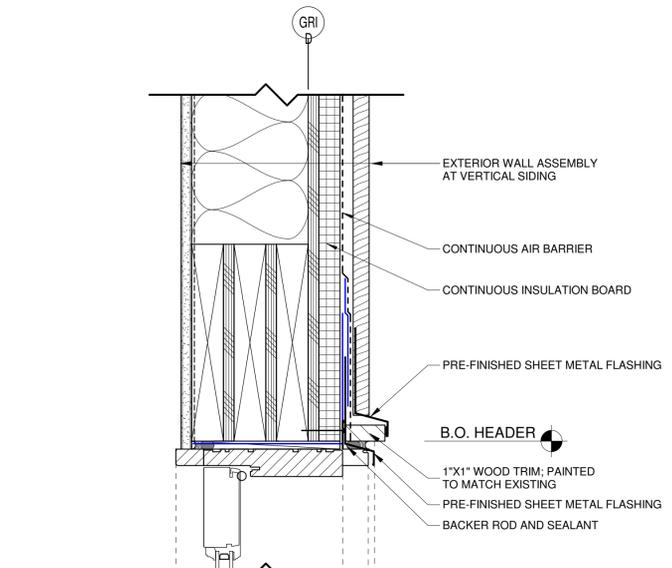


4 DOOR HEAD @ SIDING

3" = 1'-0"

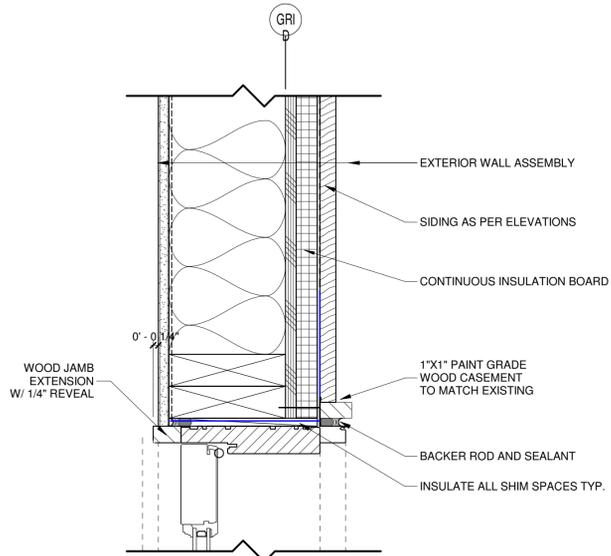


5 DOOR JAMB @ SIDING


3" = 1'-0"

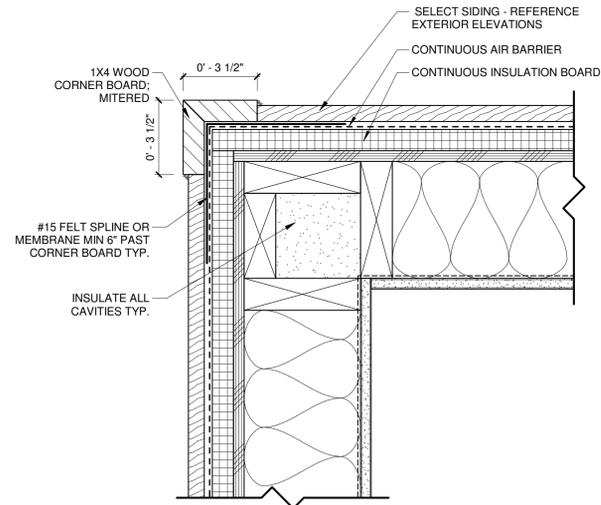


5 CORNER BOARD @ WOOD SIDING
3" = 1'-0"

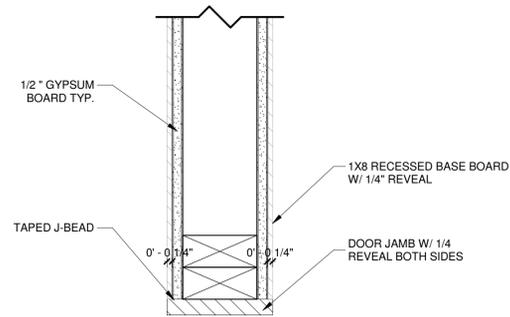


6 INTERIOR DOOR JAMB DETAIL
3" = 1'-0"

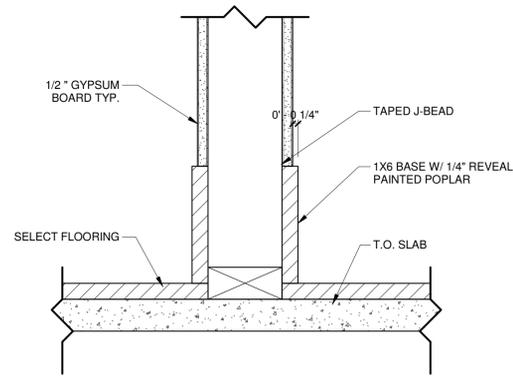


7 WOOD BASEBOARD DETAIL
3" = 1'-0"

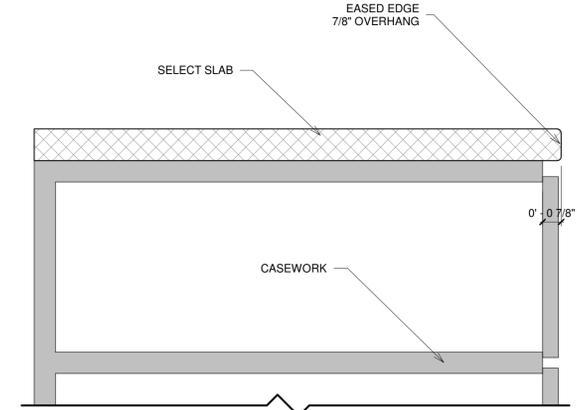


8 SLAB EDGE DETAIL
3" = 1'-0"

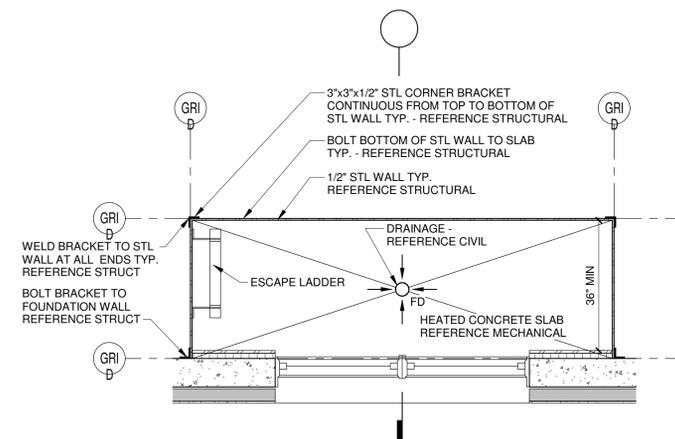


9 WINDOW WELL DETAIL
1/2" = 1'-0"

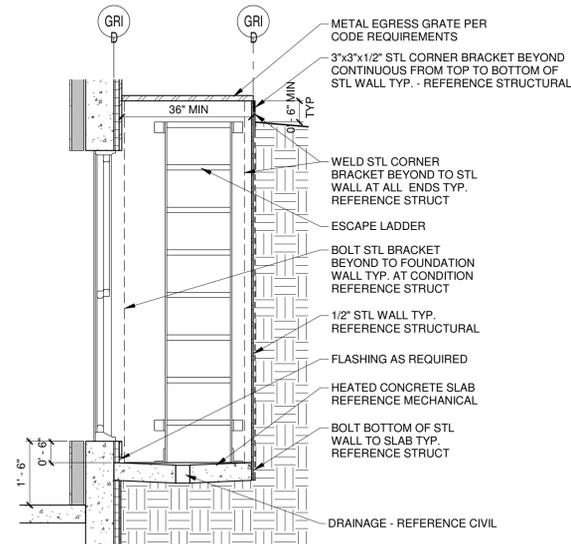


10 DECK OVER LIVING SPACE
1 1/2" = 1'-0"

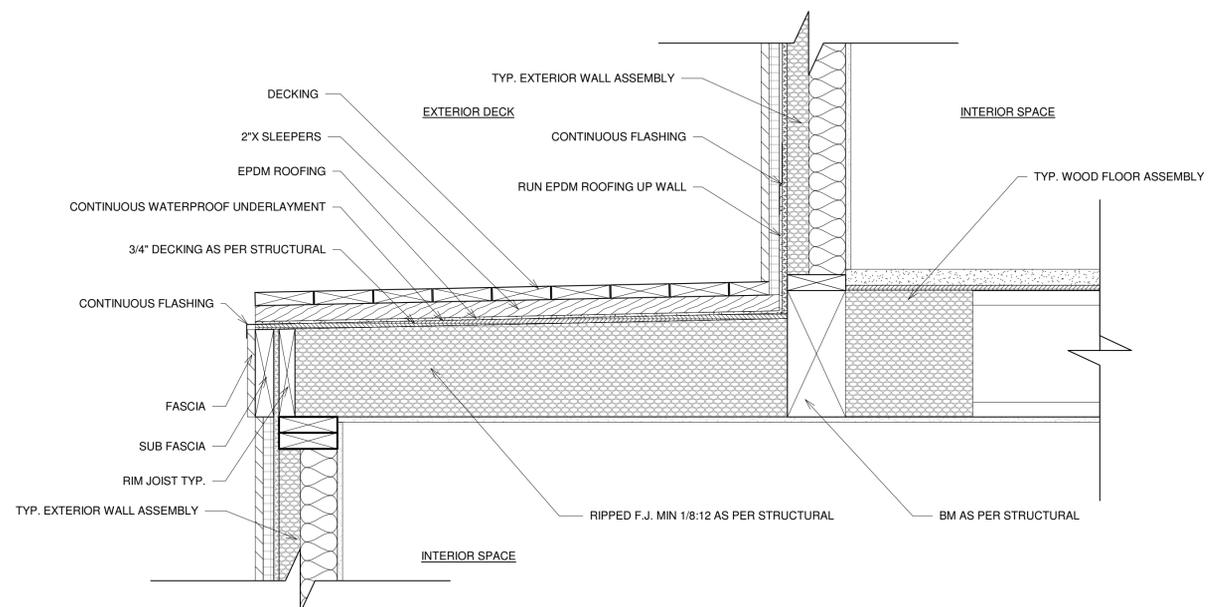

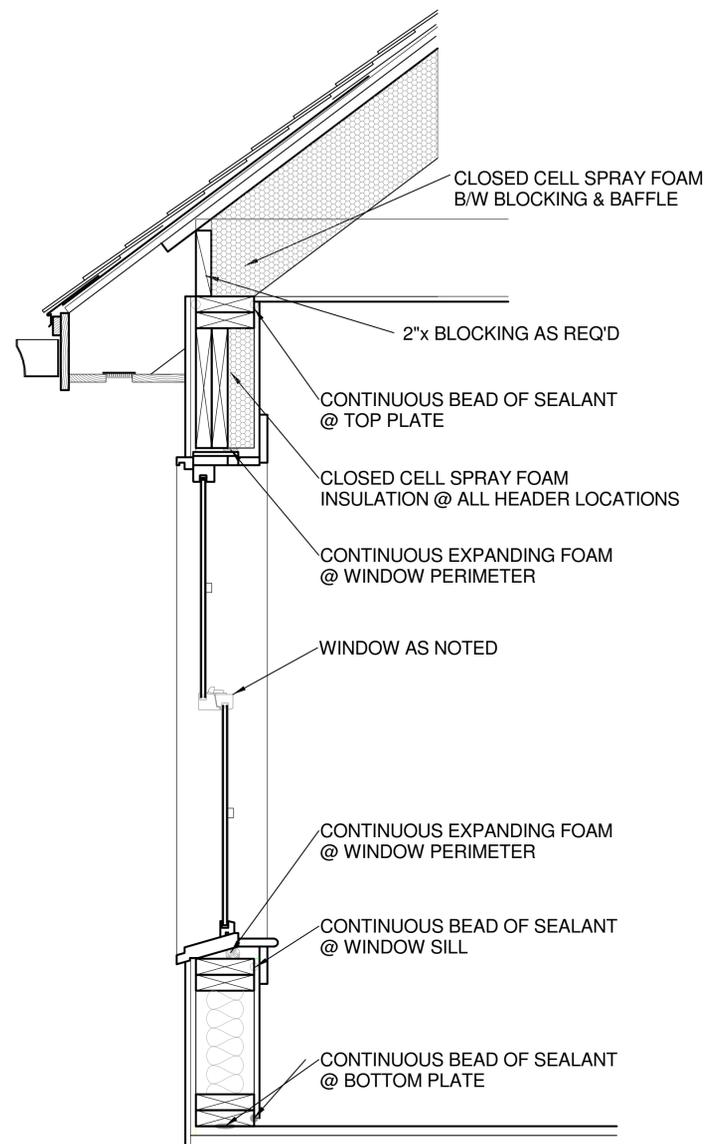


WALL / WINDOW SEALING DETAIL

1 1/2" = 1'-0"

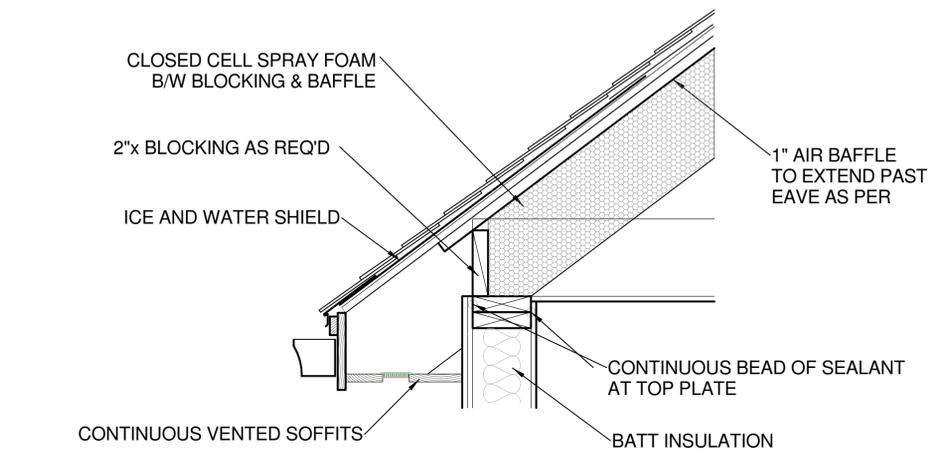


EVE SEALING DETAIL

1 1/2" = 1'-0"

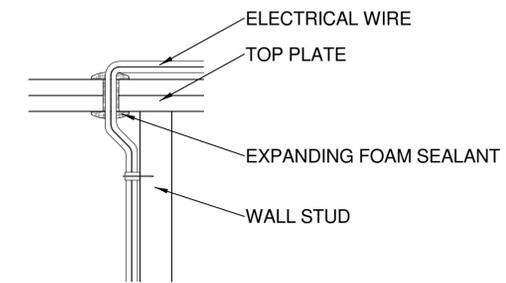


ELECTRICAL PENETRATION DETAIL

1 1/2" = 1'-0"

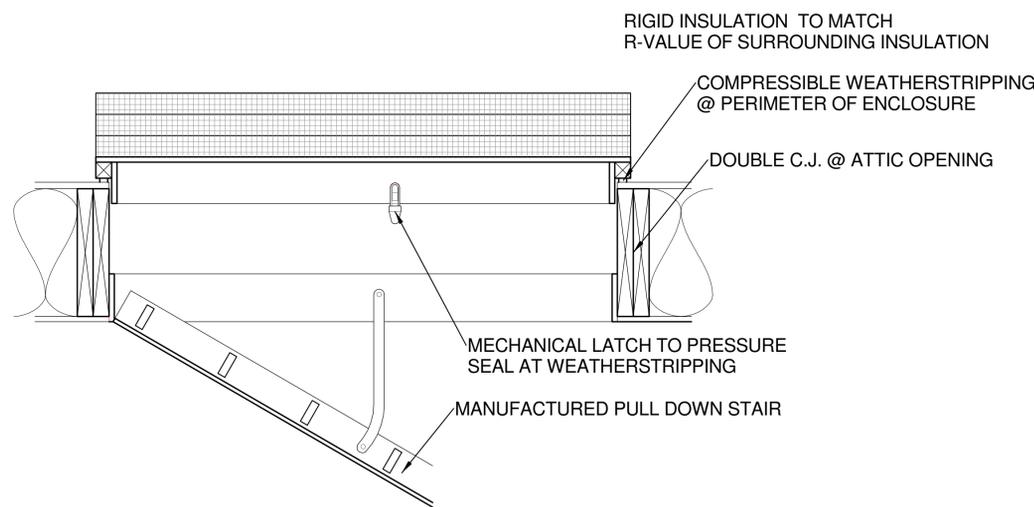


ATTIC ACCESS SEALING DETAIL

1 1/2" = 1'-0"

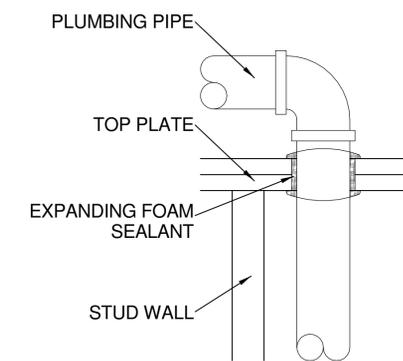


PLUMBING PENETRATION DETAIL

1 1/2" = 1'-0"

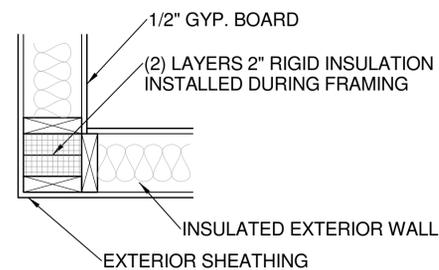

CORNER INSULATION DETAIL

1 1/2" = 1'-0"



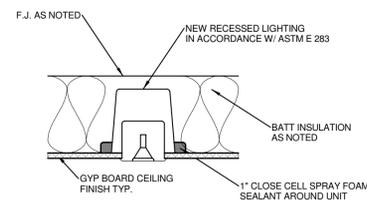


RECESSED LIGHTING SEALING DETAIL

1 1/2" = 1'-0"

WINDOW SCHEDULE							
Family	Type	Mark	Width	Height	Sill Height	STYLE	Comments
CASEMENT	2-6 X 4-0	A01	2' - 6"	4' - 0"	3' - 2 3/4"	B	MATCH DOOR HDR. HEIGHT / EGRESS
CASEMENT	2-6 X 4-0	A02	2' - 6"	4' - 0"	3' - 0"	B	
CASEMENT	2-6 X 4-0	A03	2' - 6"	4' - 0"	3' - 0"	A	EGRESS
CASEMENT	2-6 X 4-0	A04	2' - 6"	4' - 0"	3' - 0"	A	EGRESS
CASEMENT	2-6 X 4-0	A05	2' - 6"	4' - 0"	3' - 0"	A	EGRESS
CASEMENT	2-6 X 4-0	A06	2' - 6"	4' - 0"	3' - 0"	A	EGRESS
AWNING	2-6 X 3-0	B01	2' - 6"	3' - 0"	4' - 6"	D	
AWNING	2-6 X 3-0	B02	2' - 6"	3' - 0"	4' - 6"	D	
CASEMENT	2-6 X 4-0	B03	2' - 6"	4' - 0"	3' - 0"	B	EGRESS
CASEMENT	2-6 X 4-0	B04	2' - 6"	4' - 0"	3' - 0"	B	EGRESS
CASEMENT	2-0 X 4-0	B05	2' - 0"	4' - 0"	3' - 0"	E	
FIXED	3-0 X 4-6	B06	3' - 0"	4' - 6"	3' - 0"	F	
CASEMENT	2-6 X 3-6	C01	2' - 6"	3' - 6"	4' - 0"	C	
CASEMENT	2-0 X 4-6	C02	2' - 0"	4' - 6"	2' - 6"	G	
FIXED	3-0 X 4-6	C03	3' - 0"	4' - 6"	2' - 6"	G	
CASEMENT	2-0 X 4-6	C04	2' - 0"	4' - 6"	2' - 6"	G	
CASEMENT	2-0 X 4-6	C05	2' - 0"	4' - 6"	2' - 6"	G	
FIXED	3-0 X 4-6	C06	3' - 0"	4' - 6"	2' - 6"	G	
CASEMENT	2-0 X 4-6	C07	2' - 0"	4' - 6"	2' - 6"	G	
FIXED	3-0 X 4-6	C08	3' - 0"	4' - 6"	3' - 0"	F	
CASEMENT	2-0 X 4-6	C09	2' - 0"	4' - 6"	3' - 0"	H	
CASEMENT	2-0 X 4-6	C10	2' - 0"	4' - 6"	3' - 0"	H	
FIXED	3-0 X 4-6	C11	3' - 0"	4' - 6"	3' - 0"	F	
CASEMENT	2-6 X 4-0	C12	2' - 6"	4' - 0"	3' - 2"	B	

DOOR SCHEDULE						
Family	Type	Mark	Width	Height	Style	Comments
SINGLE GLASS INSWING	3-0 X 7-0	001	3' - 1 7/16"	7' - 2"	D	2/3 LIGHT / SAFETY GLASS
SINGLE FLUSH	2-8 X 6-8	002	2' - 8"	6' - 8"	A	
POCKET DOOR	2-4 X 6-8	003	2' - 4"	6' - 8"	B	
SINGLE FLUSH	2-8 X 6-8	004	2' - 8"	6' - 8"	A	
SINGLE FLUSH	2-0 X 6-8	005	2' - 0"	6' - 8"	A	
SINGLE FLUSH	2-6 X 6-8	006	2' - 6"	6' - 8"	A	
SINGLE FLUSH	2-6 X 6-8	007	2' - 6"	6' - 8"	A	
SINGLE FLUSH	2-8 X 6-8	101	2' - 8"	6' - 8"	A	
SINGLE FLUSH	2-0 X 6-8	102	2' - 0"	6' - 8"	A	
SINGLE FLUSH	2-8 X 6-8	103	2' - 8"	6' - 8"	A	
SINGLE FLUSH	2-4 X 6-8	104	2' - 4"	6' - 8"	A	
SINGLE FLUSH	2-4 X 6-8	105	2' - 4"	6' - 8"	A	
SINGLE FLUSH	2-4 X 6-8	106	2' - 4"	6' - 8"	A	
SINGLE GLASS OUTSWING	3-0 X 7-0	107	3' - 1 7/16"	7' - 2"	D	2/3 LIGHT / SAFETY GLASS
3 PANEL SLIDING GLASS	9-0 X 7-0	201	9' - 2 3/4"	7' - 2"	C	2/3 LIGHT / SAFETY GLASS

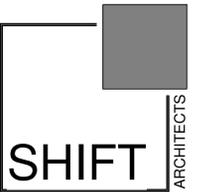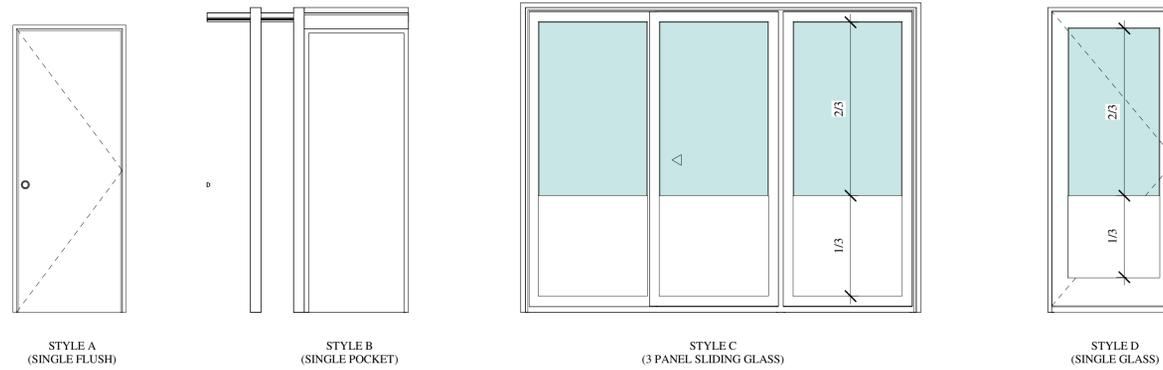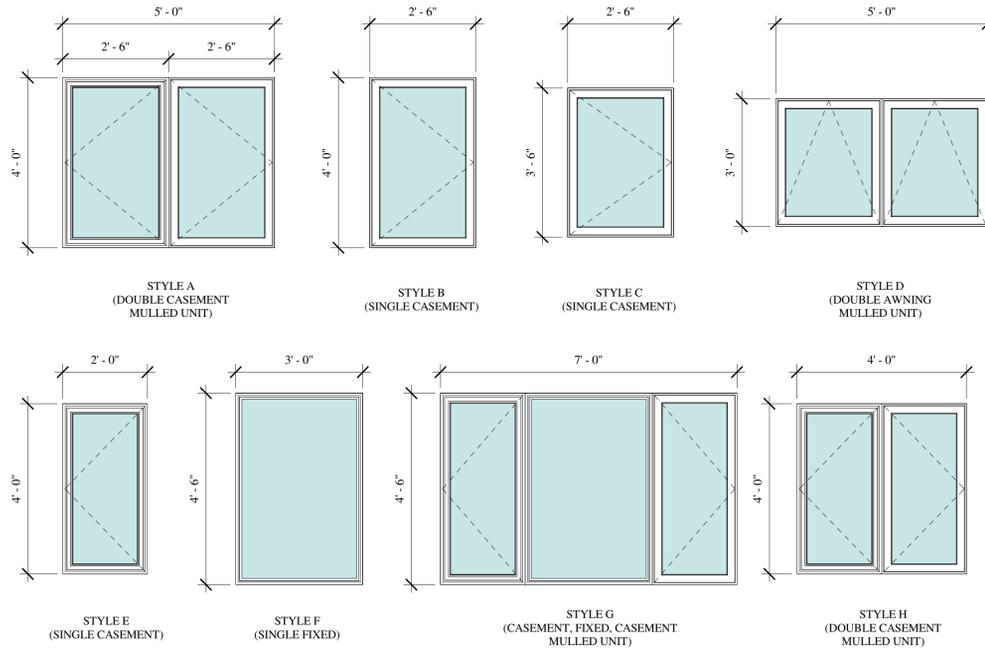

P.O. Box 3206
 100 W. Colorado Suite 211
 Telluride, Colorado 81435
 p 970-728-8145
 kristine@shift-architects.com
 www.shift-architects.com

DATE:
 REVISED HOA SET 07.07.22

MALLETTE RESIDENCE

747 W PACIFIC AVE UNIT 402
 TELLURIDE, CO 81435

DOOR / WINDOW
 SCHEDULE



SHEET NUMBER

7/7/2022 4:36:29 PM

A8.1

PLUMBING SCHEDULE

ROOM #	ROOM NAME	COUNT	TYPE	MANUFACTUR...	MODEL	FINISH	COMMENTS
003	FULL BATH	1	FAUCET	KOHLER	K-14402-4A-BN	BRUSHED...	
		1	SINK	KOHLER	Ladena K-2215-0	WHITE	INSTALLATION-UNDERMOUNT
		1	TOILET	TOTO; AQUIA	SKU:...	#01 COTTON	
		1	SHOWER / TUB FILLER	KOHLER	K-T99763-4G-CP	BRUSHED...	
		1	TOILET PAPER HOLDER	KOHLER	K-26638-CP	BRUSHED...	
		3	WALL HOOKS	KOHLER	K-26636-CP	BRUSHED...	
		1	TUB	KOHLER	K-847-0	WHITE	
103	KITCHEN	1	FAUCET	KOHLER	K-24982	VIBRANT...	
		1	SINK	KOHLER	K-3942-3...	STAINLESS...	INSTALLATION-TOPMOUNT
		1	DISPOSAL	INSINKERATOR	1/2 HP	STAINLESS...	COUNTERTOP SWITCH
		1	SOAP DISPENSER	KOHLER	K-1895-C-VS	VIBRANT...	
202	MASTER...	1	FAUCET	KOHLER	K-14406-4-G	BRUSHED...	
		1	SINK	KOHLER	Ladena K-2214-0	WHITE	INSTALLATION-UNDERMOUNT
		1	TOILET	TOTO; AQUIA	SKU:...	#01 COTTON	
		1	SHOWER HEAD HAND SHOWER/...	KOHLER	KSS-PURIST-4-RTHS-...	BRUSHED...	
		1	TOILET PAPER HOLDER	KOHLER	TP-14444-BN	BRUSHED...	
		3	WALL HOOKS	KOHLER	TP-14443-BN	BRUSHED...	

APPLIANCE SCHEDULE

ROOM #	ROOM NAME	COUNT	FAMILY	MANUFACTUR...	MODEL	FINISH	COMMENTS
005	LAUNDRY	1	WASHER	BOSCH	WAW285H2UC	WHITE	STACKABLE
005	LAUNDRY	1	DRYER	BOSCH	WTG865H4UC...	WHITE	STACKABLE
202	KITCHEN	1	36" RANGE	WOLF	DF36450G/SP...	STAINLESS	DUEL FUEL
202	KITCHEN	1	36"...	SUBZERO	IT-36CL...	PANEL READY	
202	KITCHEN	1	HOOD VENT	WOLF	PW362718...	STAINLESS	
202	KITCHEN	1	MICROWAVE	WOLF	MDD24TE/S/TH	STAINLESS	IN CABINET
202	KITCHEN	1	DISHWASHER	BOSCH	SHVM78Z53N	PANEL READY	
204	LIVING	1	GAS FIREPLACE	HEAT & GLO	COSMO42-IFT-B	CLEAN FACE	

FINISH SCHEDULE

Name	Number	FLOOR	BASE	WINDOW & DOOR TRIM	WALLS	Ceiling Finish	SHOWER FLOOR	SHOWER WALLS	BACKSPLASH	COUNTER
GUEST ROOM	001	WOOD	BASE # 1	TRIM # 1	PAINTED SKIP TROWEL	PAINTED SKIP TROWEL				
MUDROOM	002	WOOD	BASE # 1	TRIM # 1	PAINTED SKIP TROWEL	PAINTED SKIP TROWEL				
FULL BATH	003	TILE # 3	BASE # 1	TRIM # 1	PAINTED SKIP TROWEL	PAINTED SKIP TROWEL	TILE # 3 4X4	TILE # 2		SLAB # 1
BEDROOM	004	WOOD	BASE # 1	TRIM # 1	PAINTED SKIP TROWEL	PAINTED SKIP TROWEL				
LAUNDRY	005	TILE # 3	BASE # 1	TRIM # 1	PAINTED SKIP TROWEL	PAINTED SKIP TROWEL				SLAB # 1
MASTER BEDROOM	101	WOOD	BASE # 1	TRIM # 1	PAINTED SKIP TROWEL	PAINTED SKIP TROWEL				
MASTER CL.	102	WOOD	BASE # 1	TRIM # 1	PAINTED SKIP TROWEL	PAINTED SKIP TROWEL				
MASTER BATH	103	TILE # 5	BASE # 1	TRIM # 1	TILE # 7	PAINTED SKIP TROWEL	TILE # 5 4X4	TILE # 7		SLAB # 1
OFFICE	104	WOOD	BASE # 1	TRIM # 1	PAINTED SKIP TROWEL	PAINTED SKIP TROWEL				
LOWER FOYER	105	WOOD	BASE # 1	TRIM # 1	PAINTED SKIP TROWEL	PAINTED SKIP TROWEL				
FOYER	201	WOOD	BASE # 1	TRIM # 1	PAINTED SKIP TROWEL	PAINTED SKIP TROWEL				
KITCHEN	202	WOOD	BASE # 1	TRIM # 1	PAINTED SKIP TROWEL	PAINTED SKIP TROWEL			TILE # 4	SLAB # 1
DINING	203	WOOD	BASE # 1	TRIM # 1	PAINTED SKIP TROWEL	PAINTED SKIP TROWEL				
LIVING	204	WOOD	BASE # 1	TRIM # 1	PAINTED SKIP TROWEL	PAINTED SKIP TROWEL				
ENTRY	205	WOOD	BASE # 1	TRIM # 1	PAINTED SKIP TROWEL	PAINTED SKIP TROWEL				

CABINETS:

KITCHEN CABINETS:

-WOOD; RIFTED WHITE OAK, LIGHT WIRE
-FLAT PANEL; ANTIQUED GRAY OAK FINISH

BATHS / MUDROOM:

-WOOD; RIFTED WHITE OAK, LIGHT WIRE
-FLAT PANEL; NATURAL FINISH

WOOD:

SIZE: 6" WIDE; RANDOM LENGTH

WOOD: WHITE OAK; RUSTIC

COLOR: MATTE FINISH

TILES:

TILE #1: DECORATIVE MATERIAL; BLACK
BASALT ANTIQUED FLAMED; 12"X24"

TILE #2: DECORATIVE MATERIAL; WHITE
2"X10" CASTELLON

TILE #3: DECORATIVE MATERIAL; PORCELAIN
COLLECTION; TIMEWORM LIGHT GREY
24"X24" ITEM # PTWGRYLM24

TILE #4: DECORATIVE MATERIAL; SKYLINE
HONED PAVER 4"X12"

TILE #5: DECORATIVE MATERIAL; PORCELAIN
COLLECTION; TIMEWORM, DARK GREY
24"X24" ITEM # PTWGRYDM24

TILE #6: DECORATIVE MATERIAL; AKDO
CARRARA 2"X8"

TILE #7: DECORATIVE MATERIAL; STUDIO
MOSAIC; MONTE MSS01534 SKYLINE HONED
SNOW WHITE 12"X12"

SLABS:

SLAB #1: ARIZONA TILE; DELLA TERRA
QUARTZ SILVER STALLION 3CM

BASE:

BASE #1: 1"X6" POPLAR; PAINTED TO MATCH
PLASTER

TRIM:


TRIM #1:

WINDOW:

EXTENDED WOOD JAMB W/ 1-1/2" WOOD SILL;
1/4" DRYWALL REVEAL, POPLAR, PAINTED TO
WINDOW FRAME


DOOR:

EXTENDED WOOD JAMB W/ 1/4" REVEAL;
POPLAR, PAINTED TO MATCH DOOR FRAME

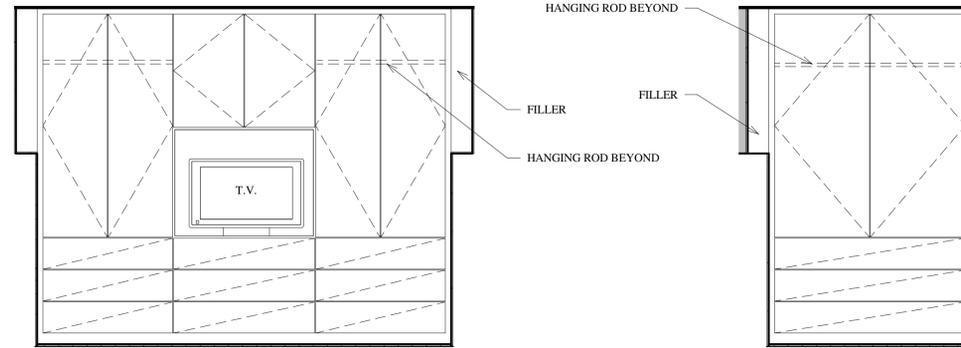


③ GUEST BEDROOM BUILT-IN
1/2" = 1'-0"


④ BEDROOM BUILT-IN
1/2" = 1'-0"

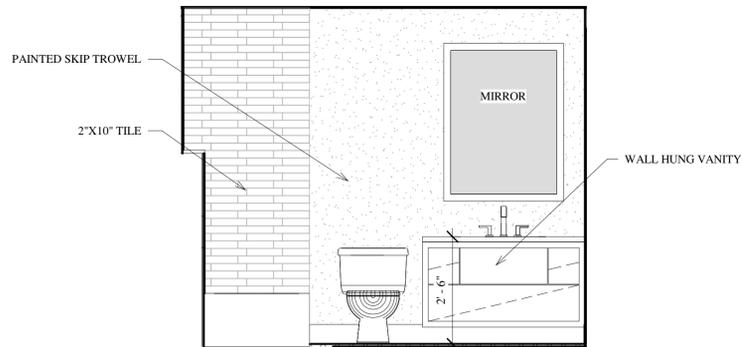


⑤ FULL BATH NORTH
1/2" = 1'-0"

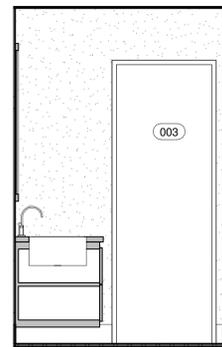


⑥ FULL BATH EAST
1/2" = 1'-0"

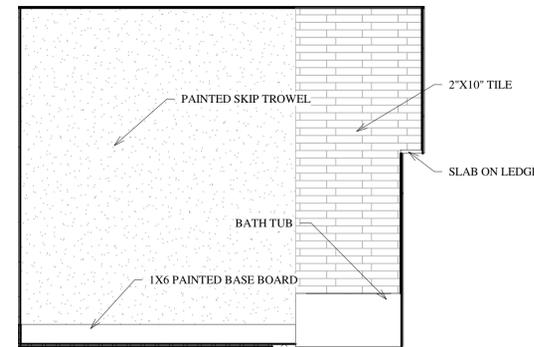


⑦ FULL BATH SOUTH
1/2" = 1'-0"

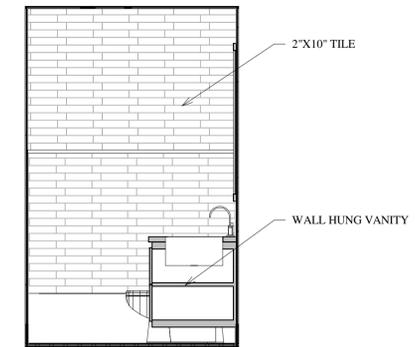

⑧ FULL BATH WEST
1/2" = 1'-0"

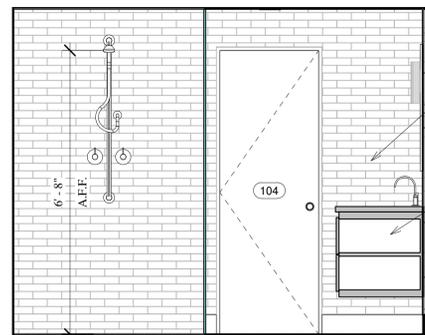


⑨ MASTER BATH NORTH
1/2" = 1'-0"

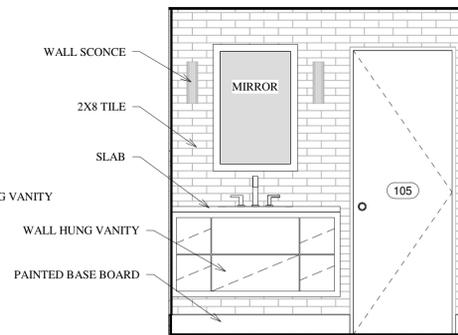


⑩ MASTER BATH EAST
1/2" = 1'-0"




⑪ MASTER BATH SOUTH
1/2" = 1'-0"

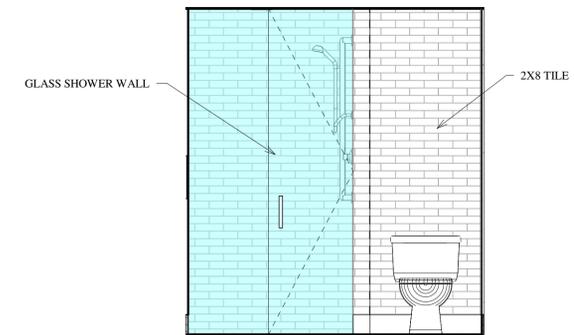


⑫ MASTER BATH WEST
1/2" = 1'-0"

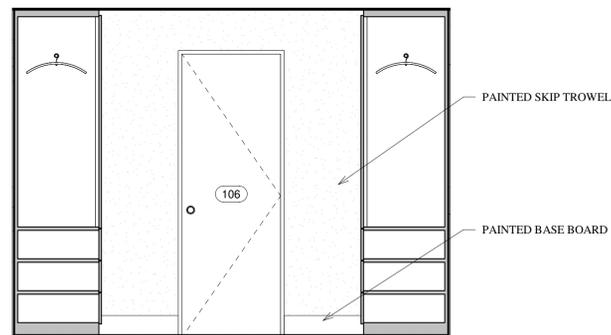


⑬ MASTER CL. NORTH
1/2" = 1'-0"

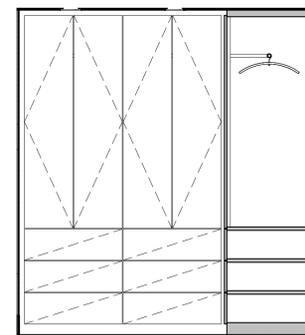


⑭ MASTER CL. EAST
1/2" = 1'-0"

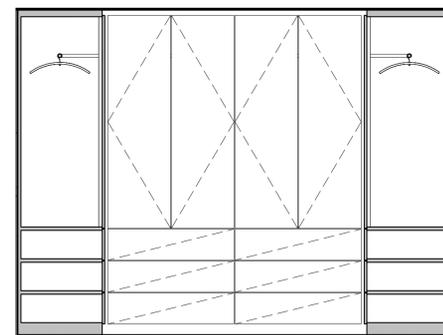


⑮ MASTER CL. SOUTH
1/2" = 1'-0"

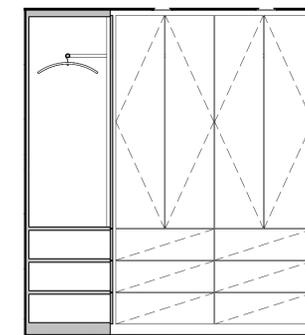


⑯ MASTER CL. WEST
1/2" = 1'-0"

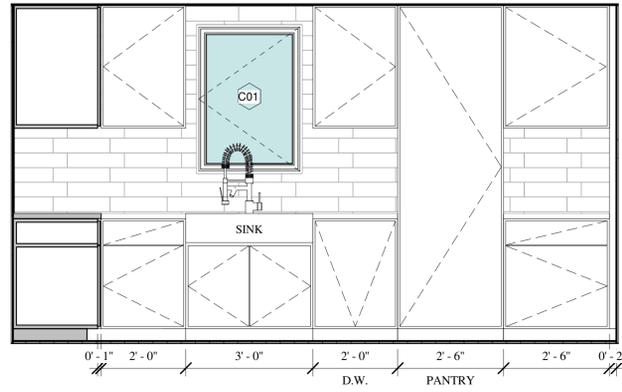


① KITCHEN SOUTH
1/2" = 1'-0"

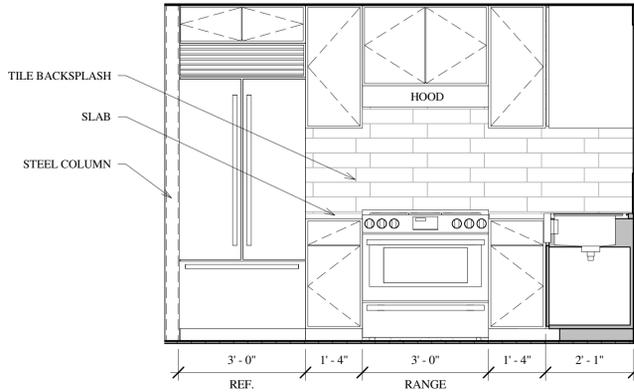


② KITCHEN EAST
1/2" = 1'-0"

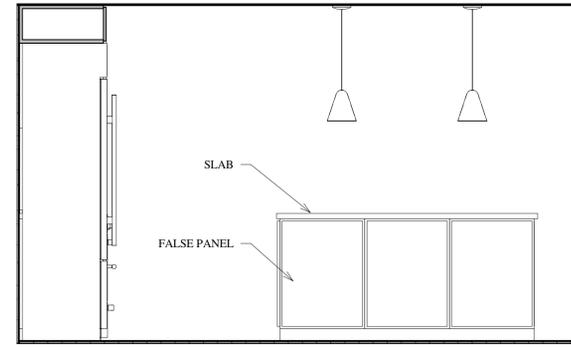


③ KITCHEN ISLAND SOUTH
1/2" = 1'-0"

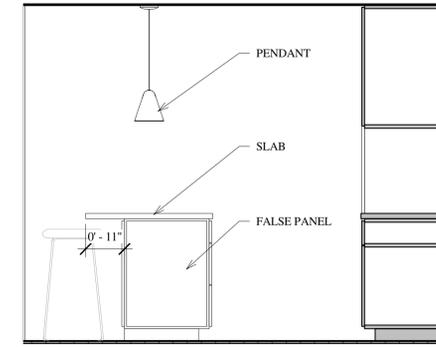


④ KITCHEN ISLAND EAST
1/2" = 1'-0"

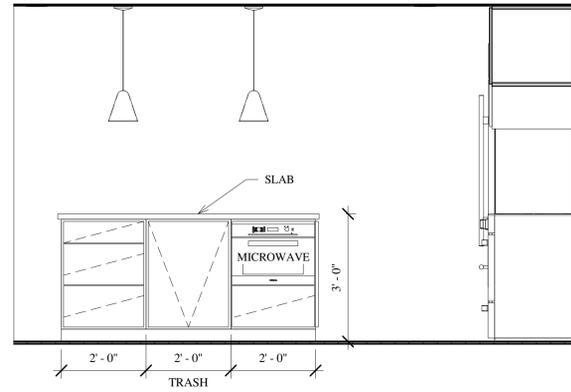


⑤ KITCHEN ISLAND NORTH
1/2" = 1'-0"

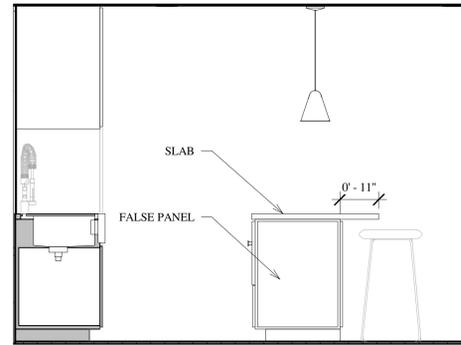


⑥ KITCHEN ISLAND WEST
1/2" = 1'-0"

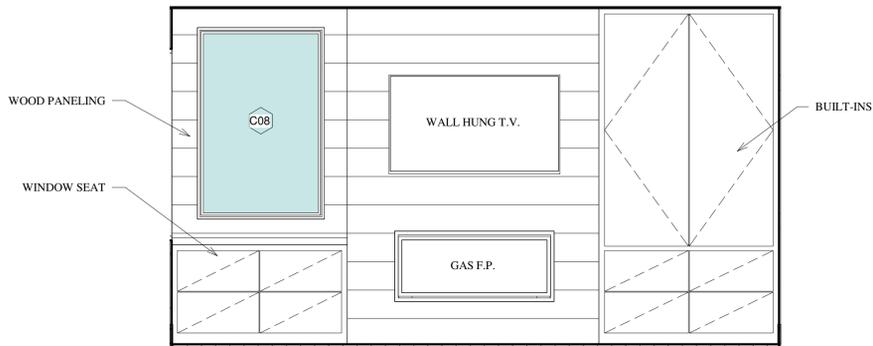

⑦ FIREPLACE
1/2" = 1'-0"

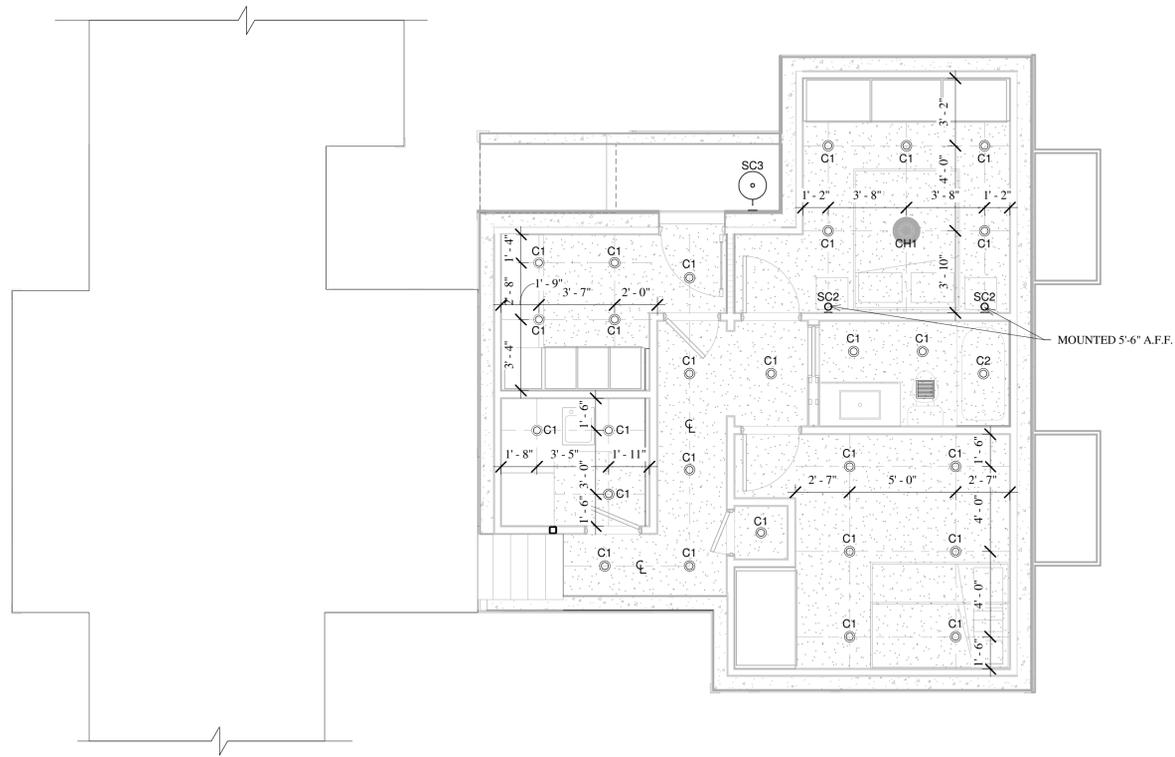

① NEW BASEMENT RCP
1/4" = 1'-0"

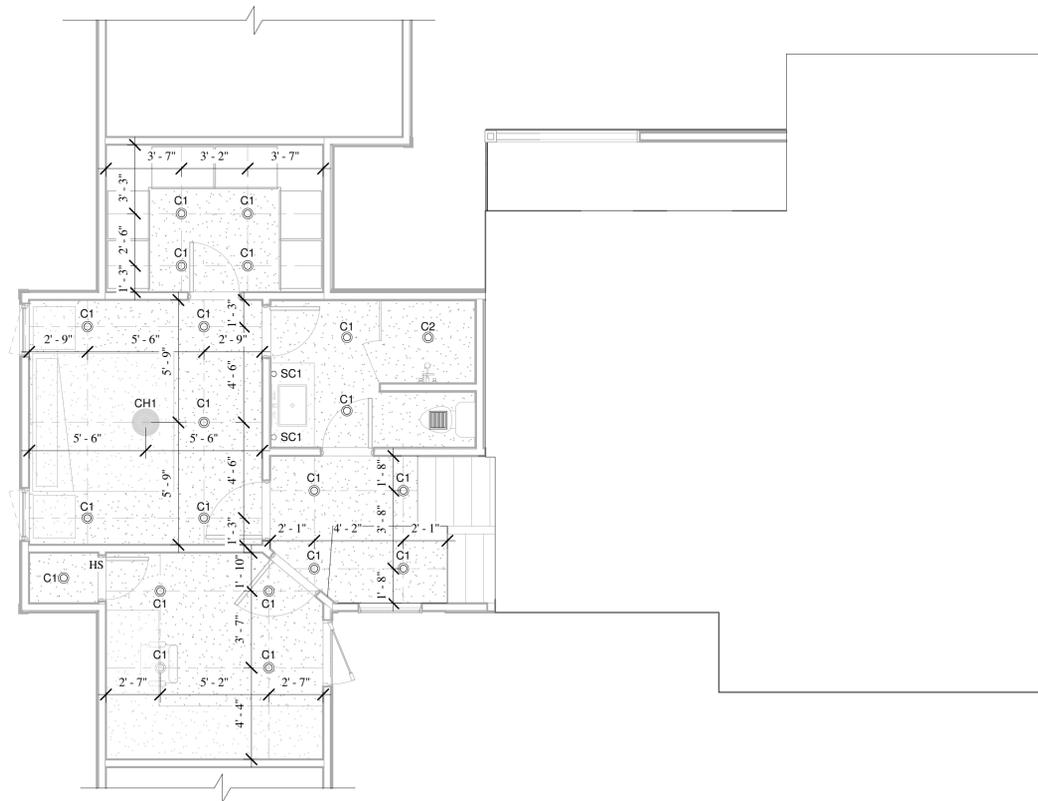


② LOWER LEVEL RCP
1/4" = 1'-0"

LIGHTING FIXTURE SCHEDULE		
Type	Type Mark	Count
4" CAN	C1	73
4" CAN WATER PROOF	C2	2
CHANDELIER 1	CH1	2
CHANDELIER	CH2	1
PENDANT	P1	2
WALL SCONCE	SC1	2
WALL SCONCE 2	SC2	2
OUTDOOR WALL SCONCE	SC3	1
Grand total: 85		



LIGHTING NOTES:

- FIELD VERIFY ALL LIGHTING LOCATIONS.
- TYPICAL LIGHTING LOCATION AT STAIRS:
(2 EA) PER LANDING
(2 EA) PER RUN
- CONTRACTOR SHALL TAKE CARE IN PLANNING ROUGH FRAMING LAYOUT AS IT RELATES TO THE NEED TO CENTER FIXTURES IN HALLWAYS, RECESSES AND OTHER AREAS WHERE RELATIONSHIPS DON'T OFFER ANY LATITUDE OR FIELD ADJUSTMENTS.
- ALL RECESSED FIXTURES AT INSULATED CEILINGS TO BE IC RATED AND CERTIFIED AIR TIGHT CONSTRUCTION. ALL EXTERIOR FIXTURES, SHOWER FIXTURES AND FIXTURES OVER TUBS TO BE MARKED "SUITABLE FOR DAMP LOCATIONS".
- ALL INTERIOR WALL SCONCES TO BE MOUNTED 5'-6" A.F.F. U.O.N.

- 4" RECESSED CAN
- PENDANT
- CHANDELIER
- WALL SCONCE
- BATHROOM EXHAUST FAN

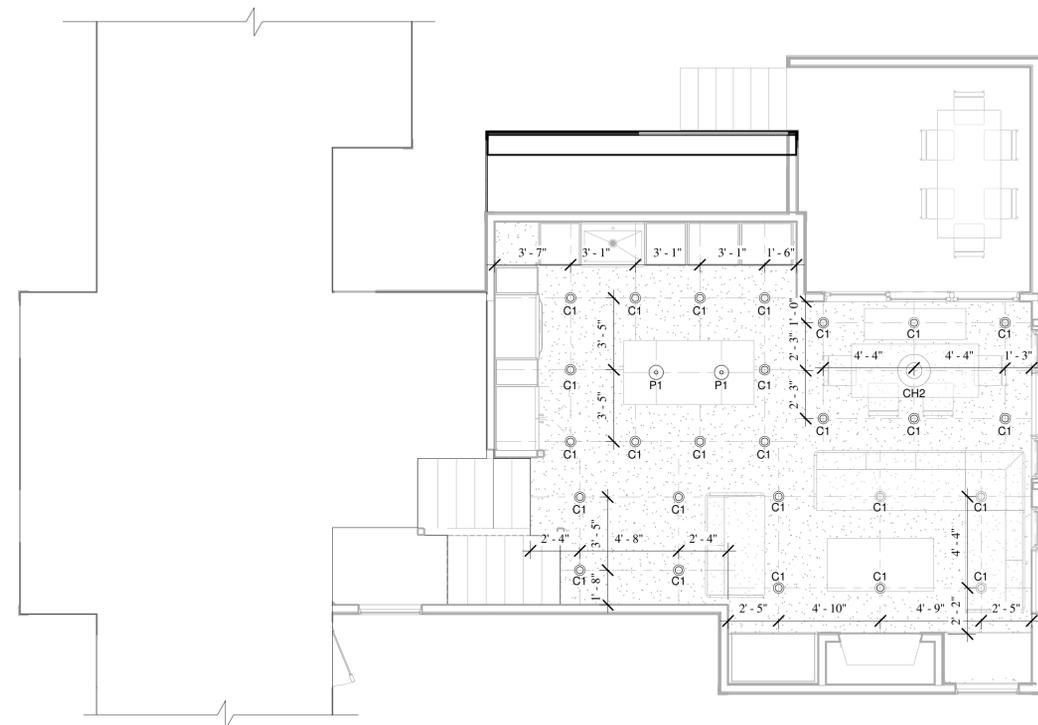

③ MAIN LEVEL RCP
1/4" = 1'-0"

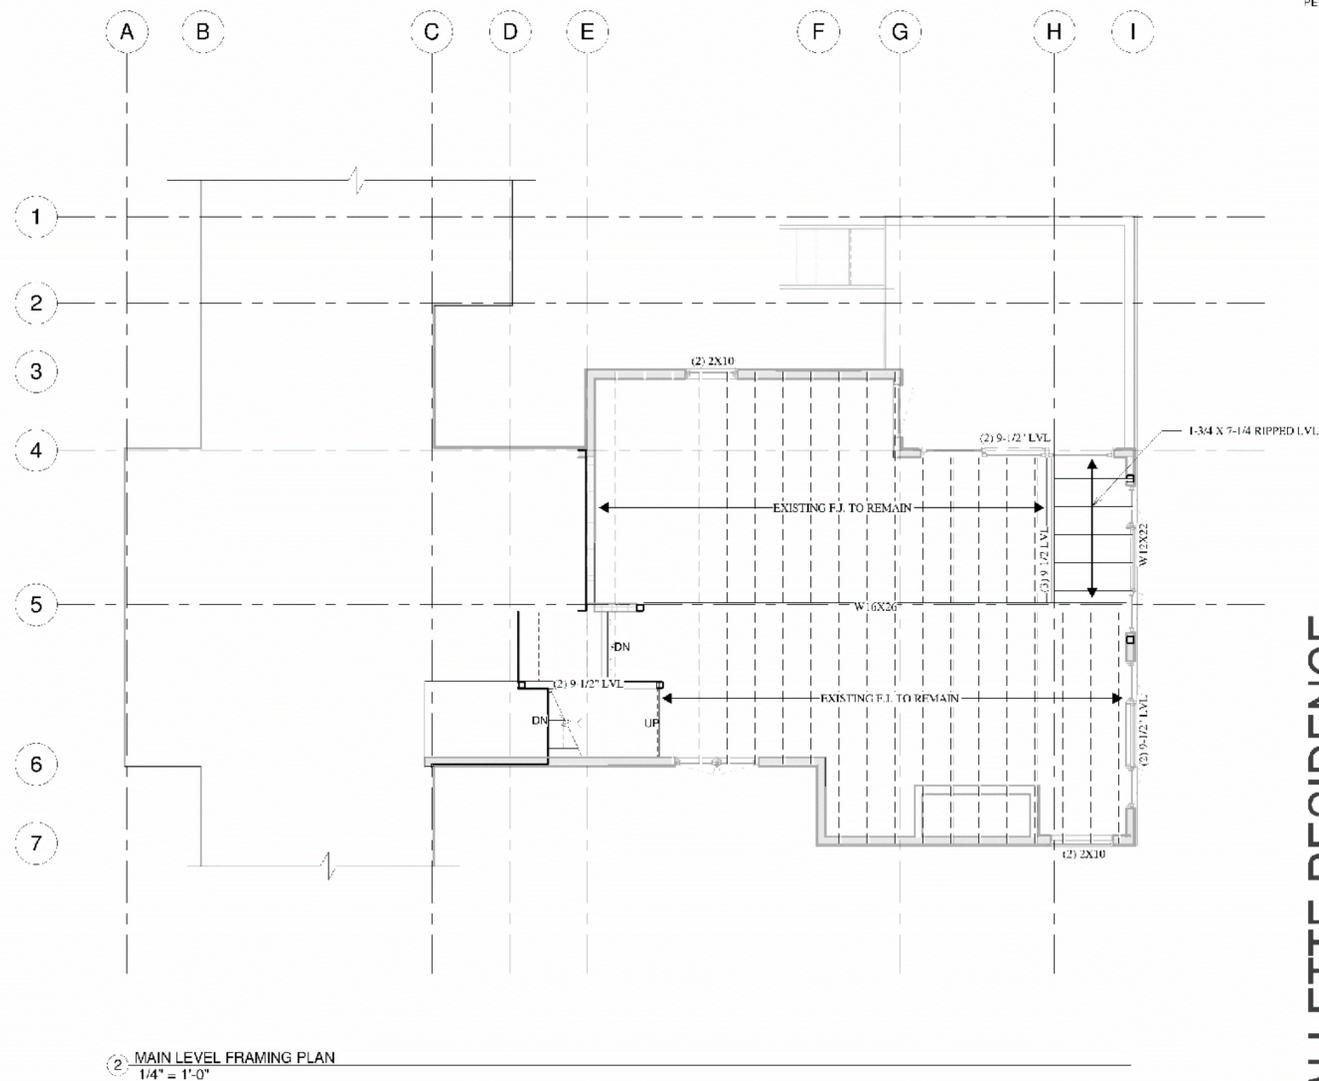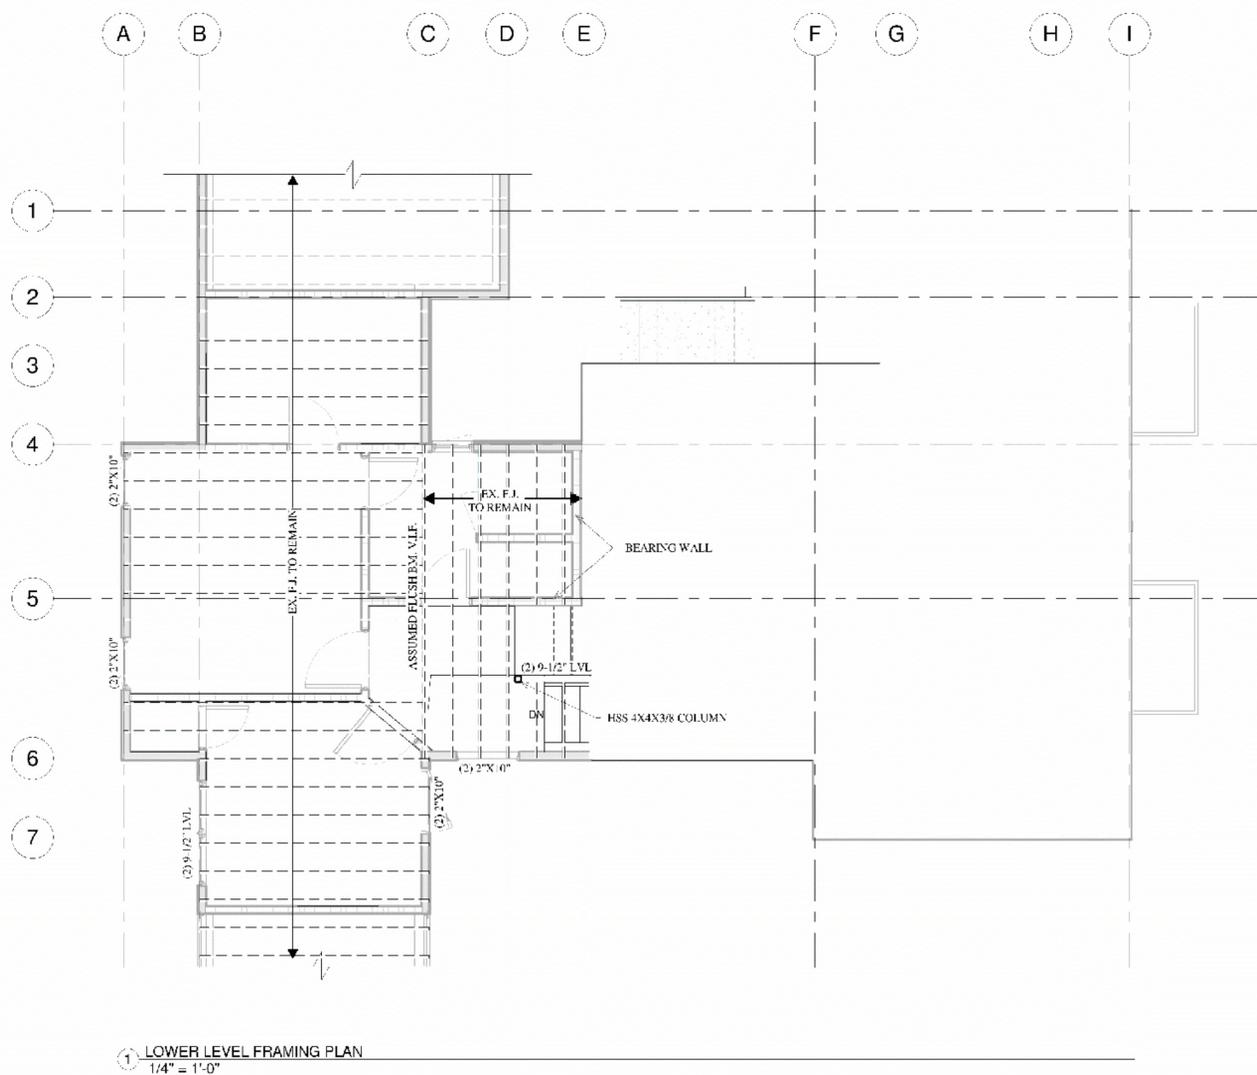

MALLETTE RESIDENCE

747 W PACIFIC AVE UNIT 402
 TELLURIDE, CO 81435

FLOOR FRAMING
 PLANS

© shift architects

SHEET NUMBER



S3

FOR HOA APPROVAL ONLY - NOT FOR CONSTRUCTION

6/23/22 14:30 PM